

STANDARD SPECIFICATION

BE ADVISED : SOME CLAUSES IN THIS SPECIFICATION MAY NOT BE RELEVANT TO THIS PROJECT

1.0 GENERAL

- 1.1 ALL DIMENSIONS SHALL BE CHECKED ON SITE PRIOR TO COMMENCEMENT OF ANY WORK
- 1.2 ALL MATERIALS SHALL COMPLY WITH RELEVANT CURRENT AUSTRALIAN STANDARDS AND UNLESS OTHERWISE STATED ON THE PLANS SHALL BE NEW AND THE BEST OF THE THEIR RESPECTIVE KIND AND SUITABLE FOR THEIR INTENDED PURPOSES.

- 1.3 ALL WORKMANSHIP SHALL COMPLY WITH RELEVANT CURRENT AUSTRALIAN STANDARDS AND TO GOOD TRADE PRACTICES
- 1.4 ALL WORK SHALL BE IN ACCORDANCE WITH REQUIREMENTS OF THE RESPECTIVE AUTHORITY HAVING JURISDICTION OVER THE WORKS.
- 1.5 THE ARCHITECTURAL DRAWINGS SHOULD BE READ IN CONJUNCTION WITH THE SPECIFICATION, SCHEDULES AND CONSULTANTS DRAWINGS THAT FORM PART OF THE CONSTRUCTION DOCUMENTS REFERRED TO IN THE "BUILDING CONTRACT".

- 1.6 DO NOT SCALE FROM DRAWINGS. NOTIFY OF ANY ERRORS OR OMISSIONS BEFORE PROCEEDING WITH ANY WORKS
- 1.7 ENSURE THAT SUBSTRATES ARE SUITABLE FOR THE INTENDED SUBSEQUENT FINISHES. COMMENCEMENT OF WORK ON THE SUBSTRATES IMPLIES ACCEPTANCE BY THE SUBCONTRACTOR OF THE SUBSTRATES ON WHICH FINISHES ARE APPLIED.

- 1.8 CONTRACTOR IS TO SUPPLY ALL EQUIPMENT NECESSARY FOR THE COMPLETION OF THE RESPECTIVE WORKS.
- 1.9 CONTRACTOR IS RESPONSIBLE FOR THE PROGRESSIVE CLEAN UP DURING AND AFTER THE COMPLETION OF RESPECTIVE WORKS

2.0 EARTHWORKS

- 2.1 UNLESS OTHERWISE STATED, REMOVE TOPSOIL TO A MINIMUM DEPTH OF 200mm INCLUDING ALL ROOTS, AND OTHER MATTER, AND REQUIRED BY THE SOIL CONDITION AND/OR BUILDER. PROVIDE SUITABLE CLEAN FILL AND COMPACT IN LAYERS NOT GREATER THAN 300mm TO REDUCE LEVELS AS SHOWN.
- 2.2 DO NOT EXCAVATE SERVICES TRENCHES WITHIN AN ANGLE OF 45 DEGREES DOWN FROM THE BOTTOM EDGE OF THE FOOTING.
- 2.3 ALL RETAINING WALLS TO BE TREATED WITH "BITKOTE" WATERPROOFING AGENT

3.0 CONCRETE

- 3.1 ALL CONCRETE REINFORCEMENT AND FORMWORK SHALL BE TO STRUCTURAL ENGINEERS DETAILS, RELEVANT BUILDING CODES AND STANDARDS
- 3.2 THE FOOTING AND SLAB CONSTRUCTION IS TO COMPLY WITH AS 2870
- 3.3 PROVIDE A PROPRIETARY VAPOUR BARRIER WHICH CONSISTS OF HIGH IMPACT RESISTANT POLYTHENE FILM MIN 0.2mm THICK WHICH HAS BEEN PIGMENTED AND BRANDED BY THE MANUFACTURER.

4.0 TERMITE PROTECTION:

- 4.1 PROVIDE ANTI-TERMITE TREATMENT UNDER THE BUILDING AREAS IN ACCORDANCE WITH AS 2057, AS 3660.1 AND APPENDIX D, FOR RETICULATED SYSTEMS.

- 4.2 BUILDER SHALL PROVIDE "BIFLEX" OR SIMILAR APPROVED ANTI-TERMITE TREATMENT IN ACCORDANCE WITH RELEVANT AUSTRALIAN STANDARD CODES

5.0 BRICKWORK

- 5.1 BRICK WORK SHALL COMPLY WITH :
AS 3700 MASONRY CODE
AS A123 MASONRY CODE
MORTAR FOR MASONRY CONSTRUCTION
- 5.2 BRICK GAUGE 7 STANDARD COURSES = 600mm.
- 5.3 TIES SHALL BE 3.5mm DIAMETER GALVANIZED WIRE KINKED FOR AND BUILT IN EVERY 5TH COURSE AT APPROXIMATELY 900mm CENTRES, WITH ADDITIONAL TIES AT THE RATE OF 1 TIE/300mm HEIGHT OF OPENINGS AND VERTICAL CONTROL JOINTS AND WITHIN 150mm OF OPENINGS. BUILD TIES INTO EACH LEAF AT LEAST 50mm.
- 5.4 VERTICAL CONTROL JOINTS SHALL BE 12mm WIDE FILLED AT COMPLETION WITH A CONTINUOUS FILLER STRIP.
- 5.5 CAVITIES TO BE KEPT CLEAR OF MORTAR. PROVIDE CAVITY BOARDS. TEMPORARILY OMIT BRICKS TO PERMIT RAKING OUT OF CAVITY BOTTOMS.
- 5.6 FORM WEEP HOLES EVERY FOURTH PERPEND ABOVE FLASHING AND CAVITY FILL KEEP CLEAR OF MORTAR. DO NOT LOCATE WEEPHOLES CLOSER THAN 500mm TO JOINTS IN DAMP PROOF COURSES OR FLASHING.
- 5.7 PROVIDE DAMP PROOF COURSES (DPC) IN THE BOTTOM 3 COURSES OF BRICK WORK AND SLAB AND/OR FOOTINGS. DPC ADDITIVE SHALL BE CLEAR IN ALL FACEWORK.
- 5.8 SETOUT BRICKWORK ACCURATELY, PLUMP, LEVEL AND PROPERLY BONDED. RISING WORK TO BE RAKED BACK, JAMBS, REVEALS, CORNERS, PERPENDS, ETC TO BE TRUE, PLUMB AND IN LINE WITH PERPENDS TRUE LINE. SETOUT DOOR FRAMES NEAR PERPENDICULAR WALL WITH A MERGIN OF 12mm OR GREATER THAN 50mm
- 5.9 PROVIDE 12mm PLASTERING MARGIN BETWEEN WINDOW FRAME AND INTERNAL BRICKWORK TO BE PLASTERED.
- 5.10 WHERE NECESSARY REINFORCE BELOW AND OVER OPENINGS WITH GALVANISED WOVEN WIRE FABRIC 75mm WIDE IN CENTRE OF EACH LEAF OPENING EXTENDING ALUMINIUM OF 600mm BEYOND THE OPENING.

- 5.11 BUILD IN ALCOR/PGI FLASHINGS AS FOLLOWS:
- WHEREVER SHOWN ON DRAWINGS
 - CAVITY WALLS BUILT OF SLAB ON GROUND (WHERE NOT PARGED)
 - OVER LINTELS TO EXPOSED OPENINGS - EXTEND THE FULL WIDTH OF OUTER LEAF CONTINUOUS ACROSS CAVITY 50mm INTO INNER LEAF 2c ABOVE
 - OVER ROOF - EXTEND THE FULL WIDTH OF EXTERNAL LEAF, STEPPED TO ROOF SLOPE TURNED DOWN MIN. 50mm OVER BASE FLASHING. TURN UP IN CAVITY SLOPING INWARDS AND BUILT INTO INNER LEAF 1c ABOVE.
 - DOOR/WINDOW STILES - EXTEND THE FULL HEIGHT 150mm WIDE FIXED TO FRAMES INTERLEAVED WITH SILL AND HEAD FLASHING AT EACH END.
 - STRUCTURE OR SERVICES WITHIN 30mm OF OUTER BRICK LEAF IN CAVITY: VERTICAL FLASHING CONTINUOUS 1c BELOW FL TO ABOVE STRUCTURE OR FRAME. NOMINAL 300m WIDE.
 - FOR HORIZONTAL STRUCTURES/SERVICES: CONTINUOUS FLASHING BUILT IN AS FOR OVER LINTELS
 - AT CAVITY WALLS WITH GLASS BLOCK 300mm WIDE FIXED TO GLASS BLOCK FRAME AND TURNED AWAY IN CAVITY FROM INNER LEAF.
- 5.12 WHERE NECESSARY REINFORCE BELOW AND OVER OPENINGS WITH GALVANISED WOVEN WIRE FABRIC 75mm WIDE IN CENTRE OF EACH LEAF OPENING EXTENDING ALUMINIUM OF 600mm BEYOND THE OPENING.
- 5.13 UNLESS OTHERWISE SHOWN ON DRAWINGS
EXTERNAL FACE WORK: 230x110x76mm
WINDOW SILLS: 2c FACE BRICK SPLAYED SILLS
WINDOW HEADS: SOLID FACEBRICK COURSE

6.0 LINTELS

MAX SPAN (mm)	LINTELS SIZE (VERT x HORIZ x THICK)	BEARING EACH END (mm)
900	75x10	150
1200	75x75x8	150
1500	90x90x8	150
1800	100x75x8	230
2100	125x75x8	230
2400	125x75x10	230
2500	100x100x8	230
3000	150x90x10	230

7.0 CARPENTRY WORK

- 7.1 ROOF AND CEILING FRAMING SHOULD COMPLY WITH AS 1684 LIGHT TIMBER FRAMING CODE. DRAW STRAP FIRMLY OVER WALL PLATES AND SECURELY FIX TO TOP OF PLATE BY 2x30mm GALV. CLOUTS/STRAP.
- 7.2 REFER TO AS 1684 FOR ROOF FRAMING SIZES UNLESS SPECIFIED ON DRAWINGS.
- 7.3 SUPPLY AND FIX ALL BULKHEADS & FALSE CEILINGS AS SHOWN ON THE DRAWINGS.

8.0 ROOFING

- 8.1 SELECTED ROOFING MATERIAL SHALL BE INSTALLED AND FIXED IN ACCORDANCE WITH MANUFACTURERS SPECIFICATION AND RELEVANT BUILDING CODES
- 8.2 GUTTER, FASCIA, DOWNPIPES, FLASHING SHALL BE IN LONGEST POSSIBLE LENGTHS
- 8.3 ALLOW FOR ALL JOINTS AND JOINING MATERIALS, COLLARS, STRAPS & FASTENINGS NECESSARY TO COMPLETE WORK.
- 8.4 ALLOW FOR ALL ROOF PENETRATIONS, ROOF COWLS, FLASHING, FLUMES THROUGH ROOF
- 8.5 FIX GUTTERS & FLASHING TO PERMIT THERMAL MOVEMENT IN THEIR FULL LENGTH

- 8.6 SEAL BETWEEN OVERLAPPING FLASHING; FLASHING TURNED DOWN OVER BASE OR APRON FLASHING; FLASHING OVER METAL ROOF; FLASHING OVER SECRET GUTTERS; AROUND ROOF PENETRATIONS ETC.

9.0 WINDOWS/GLAZING

- 9.1 UNLESS OTHERWISE STATED ON THE DRAWINGS WINDOW FRAMES SHALL BE ALUMINIUM RESIDENTIAL OR COMMERCIAL IN SECTION WITH POWDERCOAT FINISH AS SELECTED BY OWNER.
- 9.2 ALLOW FOR FLYSCREENS TO BE FITTED TO ALL WINDOWS.
- 9.3 ANGLED WINDOW UNITS SHALL BE FACTORY MADE AND FIXED AND DELIVERED ON SITE AS A COMPLETE UNIT.
- 9.4 WHERE RELEVANT WINDOWS ARE TO COMPLY WITH THE SPECIFICATIONS PROVIDED BY THE THERMAL PERFORMANCE ASSESSOR.
- 9.5 CLEAR GLASS GENERALLY: OBSCURE GLASS TO BATHROOMS, REFER TO DRAWINGS.

- 9.6 WHERE GLASS BLOCKS HAVE BEEN NOMINATED, THEY SHALL BE IN FRAMES AND INSTALLED TO MANUFACTURERS SPECIFICATIONS

10.0 JOINERY

- 10.1 ALL JOINERY SHALL BE OF HIGHEST QUALITY MATERIALS TO BEST TRADE PRACTICES AND HIGH QUALITY FINISH.
- 10.2 EXTERNAL DOOR FRAMES SHALL BE: 110x40 DOUBLE REBATED FRAME WITH 130x40 WEATHERED THRESHOLD U.N.O.
- 10.3 SUPPLY AND BUILD IN TIMBER DOOR FRAMES TO EXTERNAL LOCATIONS AS SHOWN ON ARCHITECTURAL DRAWINGS.

11.0 CEILINGS

- 11.1 CEILINGS SHALL BE RECESSED EDGE, MINIMUM 8.0mm PLASTERGLASS OR GYPROCK.

- 11.2 FLUSH JOINTS, SCREW HEADS, AND OTHER BLEMISHES IN THE SHEETS USING APPROVED SYSTEMS TO PROVIDE FLUSH SMOOTH CONTINUOUS SURFACE
- 11.3 PROVIDE AND FIX ALL FLUSH STOP BEADS & CASING BEADS TO ALL CORNERS & EDGES

- 11.4 PROVIDE ALL SELECTED MOLDINGS AND CORNICES TO ALL CEILINGS AS SHOWN ON THE DRAWINGS.

12.0 PLASTERING

- 12.1 INTERNAL WALL FINISHES INCLUDING CUPBOARD, BIN & FRIDGE RECESSES ETC SHALL BE (OTHER THAN FACE FINISHES OR WHERE COVERED BY FEATURE MATERIALS) FLOAT AND SET IN HARDWALL PLASTER U.N.O.
- 12.2 PLASTERED WALLS SHALL BE NOMINAL 12mm THICK CONSISTING OF 1:1:9, CEMENT:LIME:SAND RENDER, AND FINISHED WITH NOMINALLY 3mm HARDWALL PLASTER
- 12.3
- 12.4 SUPPLY AND FIX EXTERNAL CORNER BEADS TO ALL EXTERNAL CORNERS. PROVIDE STOP BEADS WHERE PLASTER WORK ABUTS TIMBER FRAMES, OR FACEWORK
- 12.5 EXTERNAL RENDER WHEN APPLICABLE SHALL BE 2 COAT SAND FINISH. (FOR PAINTING).
- 12.6 NIBS IN INTERNAL CORNERS ADJACENT TO DOOR FRAMES GREATER THAN 40mm SHALL NOT BE FLUSHED UP WITH FRAMES.
- 12.7 PROVIDE V-JOINTS IN RENDER & FINISHING PLASTER WHERE BRICK WORK ABUTS OR JOINS ONTO CONCRETE WORK.

13.0 FLOORING FINISHES

- 13.1 CARPET FLOOR COVERINGS TO NOMINATED AREAS COMPLETE WITH SELECTED UNDERLAY SMOOTH EDGE, DIMINISHING STRIPS ETC, TO COMPLETE THE WORKS: REFER TO DRAWINGS
- 13.2 AND FINISHES SCHEDULE
PROVIDE TILED FLOOR FINISHES TO NOMINATED AREAS COMPLETE WITH ALL MATERIALS, ANGLE TRIMS ETC. TO COMPLETE THE WORKS: REFER TO DRAWINGS AND FINISHES
- 13.3 SCHEDULE
PROVIDE TIMBER FLOOR FINISHES TO NOMINATED AREAS COMPLETE WITH ALL MATERIALS, DIMINISHING BOARDS ETC TO COMPLETE THE WORKS: FLOOR BOARDS TO BE SANDED AND POLISHED TO HIGH STANDARD WITH PREMIUM QUALITY SEALER (2 COATS). REFER TO DRAWINGS AND FINISHES SCHEDULE.

14.0 SIGNAGE

- 14.1 WHERE NECESSARY SUPPLY & FIX SELECTED UNIT AND HOUSE NUMBERS TO EACH UNIT AND TO LETTERBOXES AS SCHEDULED.
- 14.2 "SUPERDRAFT" RESERVES THE RIGHT TO ERECT A BUILDERS SIGN ON THE PROPERTY FACING THE STREET FRONTAGE IN COMPLIANCE WITH AUTHORITY REQUIREMENTS.

15.0 PAVING

- 15.1 GENERALLY: WHEN PAVING IS INCLUDED IN THE BUILDING CONTRACT THE FOLLOWING SHALL APPLY AS A MINIMUM STANDARD
- SUPPLY AND LAY ALL PAVING TO EXTERNAL AREAS AS SHOWN ON WORKING DRAWINGS.
 - CUT, FILL & COMPACT SAND TO REQUIRED LEVELS. SCREED TO UNIFORM THINNESS AND LEVELS
 - PROVIDE BRICK EDGE RETAINING FOOTING EMBEDDED IN MORTAR BENEATH THE PAVING BRICK
 - TO DRIVEWAY AREAS, PROVIDE NOMINAL 300x150mm CONCRETE FOOTING ALONG PERIMETER OF DRIVEWAY AND BED EDGE BRICK IN MORTAR.

- 15.2 PROVIDE 100mm COMPACTED LIMESTONE BASE TO DRIVEWAY TOPPED WITH 50mm CLEAN SAND AND GRADE TO FALLS.
- 15.3
- 15.4 UNLESS NOTED PAVING PATTERN IS TO CLIENTS DETAIL
BRICK PAVERS SHALL BE:
TRAFFICABLE AREAS: MIN. 65mm SOLID CLAY OR CONCRETE
PEDESTRIAN AREAS: MIN. 43mm SOLID CLAY OR CONCRETE

16.0 ENERGY EFFICIENCY

- 16.1 INSULATION MUST FORM A CONTINUOUS BARRIER WITH CEILINGS, WALLS AND FLOORS BY ABUTTING OR OVERLAPPING ADJOINING INSULATION
- 16.2 INSULATION MUST NOT ADVERSELY AFFECT DOMESTIC SERVICES OR FITTINGS
- 16.3 REFLECTIVE INSULATION IS TO BE PROVIDED WITH A MINIMUM 25mm AIRSPACE AND IS FITTED CLOSE TO OPENINGS SUCH AS WINDOWS/DOORS ETC. AND IS PROVIDED WITH ADEQUATE SUPPORT.
- 16.4 BULK INSULATION MUST MAINTAIN ITS POSITION, THICKNESS.
- 16.5 ENSURE THAT CEILING INSULATION OVERLAPS UN-INSULATED WALLS
CONSTRUCTION JOINTS, SUCH AS BETWEEN WALL AND FLOOR, ARE TO BE TIGHT FITTING OR SEALED USING CAULKING OR JOINERY ITEMS SUCH AS SKIRTING OR CORNICES
- 16.6 EXHAUST FANS ARE TO BE FITTED WITH A SELF CLOSING DAMPER
- 16.7 ROOF LIGHTS MUST BE SEALED WITH WEATHERPROOF SEALS
- 16.8 HEATED WATER PIPING MUST BE THERMALLY INSULATED AND PROTECTED AGAINST THE WEATHER AND SUN
- 16.9 INTERNAL HEATED WATER PIPING TO HAVE AN R VALUE OF 0.2
- 16.10 ENCLOSED SUB-FLOOR AND ROOF SPACE TO HAVE AN R VALUE OF 0.45

FEMME BUILD

NEW CONSTRUCTION
REMODELS
ADDITIONS
RENOVATIONS

0403 132 106
info@femmebuild.com.au

REPRODUCTION OF THE WHOLE OR PART OF THE DOCUMENT CONSTITUTES AND INFRINGES COPYRIGHT. THE INFORMATION, IDEAS AND CONCEPTS CONTAINED IN THIS DOCUMENT IS/ARE CONFIDENTIAL. THE RECIPIENT(S) OF THIS DOCUMENT IS/ARE PROHIBITED FROM DISCLOSING SUCH INFORMATION IDEAS AND CONCEPTS TO ANY PERSON WITHOUT PRIOR WRITTEN CONSENT OF THE COPYRIGHT HOLDER. CONTRACTOR TO CHECK AND VERIFY ALL LEVELS, DATUMS, A DIMENSIONS ON SITE AND SHALL REPORT ANY DISCREPANCIES OR OMISSIONS TO THIS OFFICE PRIOR TO START OF WORK & DURING THE CONSTRUCTION PHASE. THIS DRAWING IS TO BE READ AND UNDERSTOOD IN CONJUNCTION WITH STRUCTURAL, MECHANICAL, ELECTRICAL AND/OR ANY OTHER CONSULTANTS DOCUMENTATION AS MAY BE APPLICABLE TO THE PROJECT PRIOR TO START OF WORK & ITS DURATION. MEASUREMENT SCALING OF THIS DRAWING SHALL ONLY BE PERMITTED IN ITS DIGITAL FORM.

DRAWING SCHEDULE

A.00	ARCHITECTURAL SPECIFICATION
A.01.0	PROPOSED DEMOLITION PLAN
A.01.1	PROPOSED SITE PLAN
A.01.2	PROPOSED SITE ANALYSIS PLAN
A.01.3	PROPOSED CONCEPT STORMWATER PLAN
A.01.4	PROPOSED SEDIMENT EROSION CONTROL PLAN
A.01.5	PROPOSED LANDSCAPE PLAN
A.01.6	PROPOSED SUBDIVISION PLAN
A.02.1	PROPOSED GROUND FLOOR PLAN
A.02.2	PROPOSED FIRST FLOOR PLAN
A.02.3	PROPOSED ROOF PLAN
A.03.1	PROPOSED ELEVATIONS
A.03.2	PROPOSED ELEVATIONS
A.04.1	PROPOSED SECTION & DETAILS
A.06.1	PROPOSED UNIT 1 SHADOW DIAGRAMS
A.06.2	PROPOSED UNIT 2 SHADOW DIAGRAMS
A.07.1	PROPOSED BASIX COMMITMENTS

03	AS PER COUNCIL REQUIREMENTS	SK	04.11.2024
02	AS PER COUNCIL REQUIREMENTS	SK	04.07.2024
01	DEVELOPMENT APPLICATION	SK	11.04.2023
REV	AMENDMENT DETAILS	BY	DATE

PROJECT STAGE
DEVELOPMENT APP.

PROJECT DETAILS
DETACHED DUAL-OCC

102 SANDAKAN ROAD,
REVESBY HEIGHTS

CLIENT DETAILS
LIVINGSTON HOMES

DRAWING TITLE
ARCHITECTURAL SPECIFICATION

DRAWN SK	DRAWING SCALE 1 : 000	SHEET SIZE A3
DESIGNED FB		
CHECK FB		
DATE DRAWN JULY 2024		

bd&a

**ACCREDITED
BUILDING DESIGNER**

PROJECT NUMBER FB0077	DRAWING NUMBER A.00	REVISION 03
--------------------------	------------------------	----------------

SITE NOTES


- CONFIRM ALL DIMENSIONS ON SITE TO EXISTING RESIDENCE PRIOR TO COMMENCEMENT OF ANY WORK.
- EXISTING PLUMBING AND ELECTRICAL WORKS TO BE REMOVED AND MADE GOOD AS NECESSARY.
- THIS PLAN DOES NOT PROVIDE SPECIFIC LANDSCAPE PLANTING LOCATIONS.
- THE EXACT LOCATION OF UNDERGROUND AND ABOVEGROUND SERVICES SHALL BE PROVEN ON SITE. NO GUARANTEE IS GIVEN THAT ALL EXISTING SERVICES ARE SHOWN.
- THIS DRAWING SET TO BE READ IN CONJUNCTION WITH THE SPECIFICATION PROVIDED.
- BEWARE OF EXISTING SERVICES. CONFIRM LOCATIONS PRIOR TO EXCAVATION. TAKE EXTREME CARE.
- REFER ALL MAJOR WORKS TO RAMPS, WALKWAYS, DRIVEWAYS ETC (INCLUDING CARPARK WORKS, LEVELS & DATUMS) REFER TO CIVIL ENGINEERS DOCUMENTATION.

FEMME BUILD

NEW CONSTRUCTION
REMODELS
ADDITIONS
RENOVATIONS

0403 132 106
info@femmebuild.com.au

COPYRIGHT 2023 FEMME BUILD
REPRODUCTION OF THE WHOLE OR PART OF THIS DOCUMENT CONSTITUTES AND INFRINGES COPYRIGHT. THE INFORMATION, IDEAS AND CONCEPTS CONTAINED IN THIS DOCUMENT IS / ARE CONFIDENTIAL. THE RECIPIENT(S) OF THIS DOCUMENT IS / ARE PROHIBITED FROM DISCLOSING SUCH INFORMATION IDEAS AND CONCEPTS TO ANY PERSON WITHOUT PRIOR WRITTEN CONSENT OF THE COPYRIGHT HOLDER. CONTRACTOR TO CHECK AND VERIFY ALL LEVELS, DATUMS, A DIMENSIONS ON SITE AND SHALL REPORT ANY DISCREPANCIES OR OMISSIONS TO THIS OFFICE PRIOR TO START OF WORK & DURING THE CONSTRUCTION PHASE. THIS DRAWING IS TO BE READ AND UNDERSTOOD IN CONJUNCTION WITH STRUCTURAL, MECHANICAL, ELECTRICAL AND OR ANY OTHER CONSULTANTS DOCUMENTATION AS MAY BE APPLICABLE TO THE PROJECT PRIOR TO START OF WORK & ITS DURATION. MEASUREMENT SCALING OF THIS DRAWING SHALL ONLY BE PERMITTED IN ITS DIGITAL FORM.

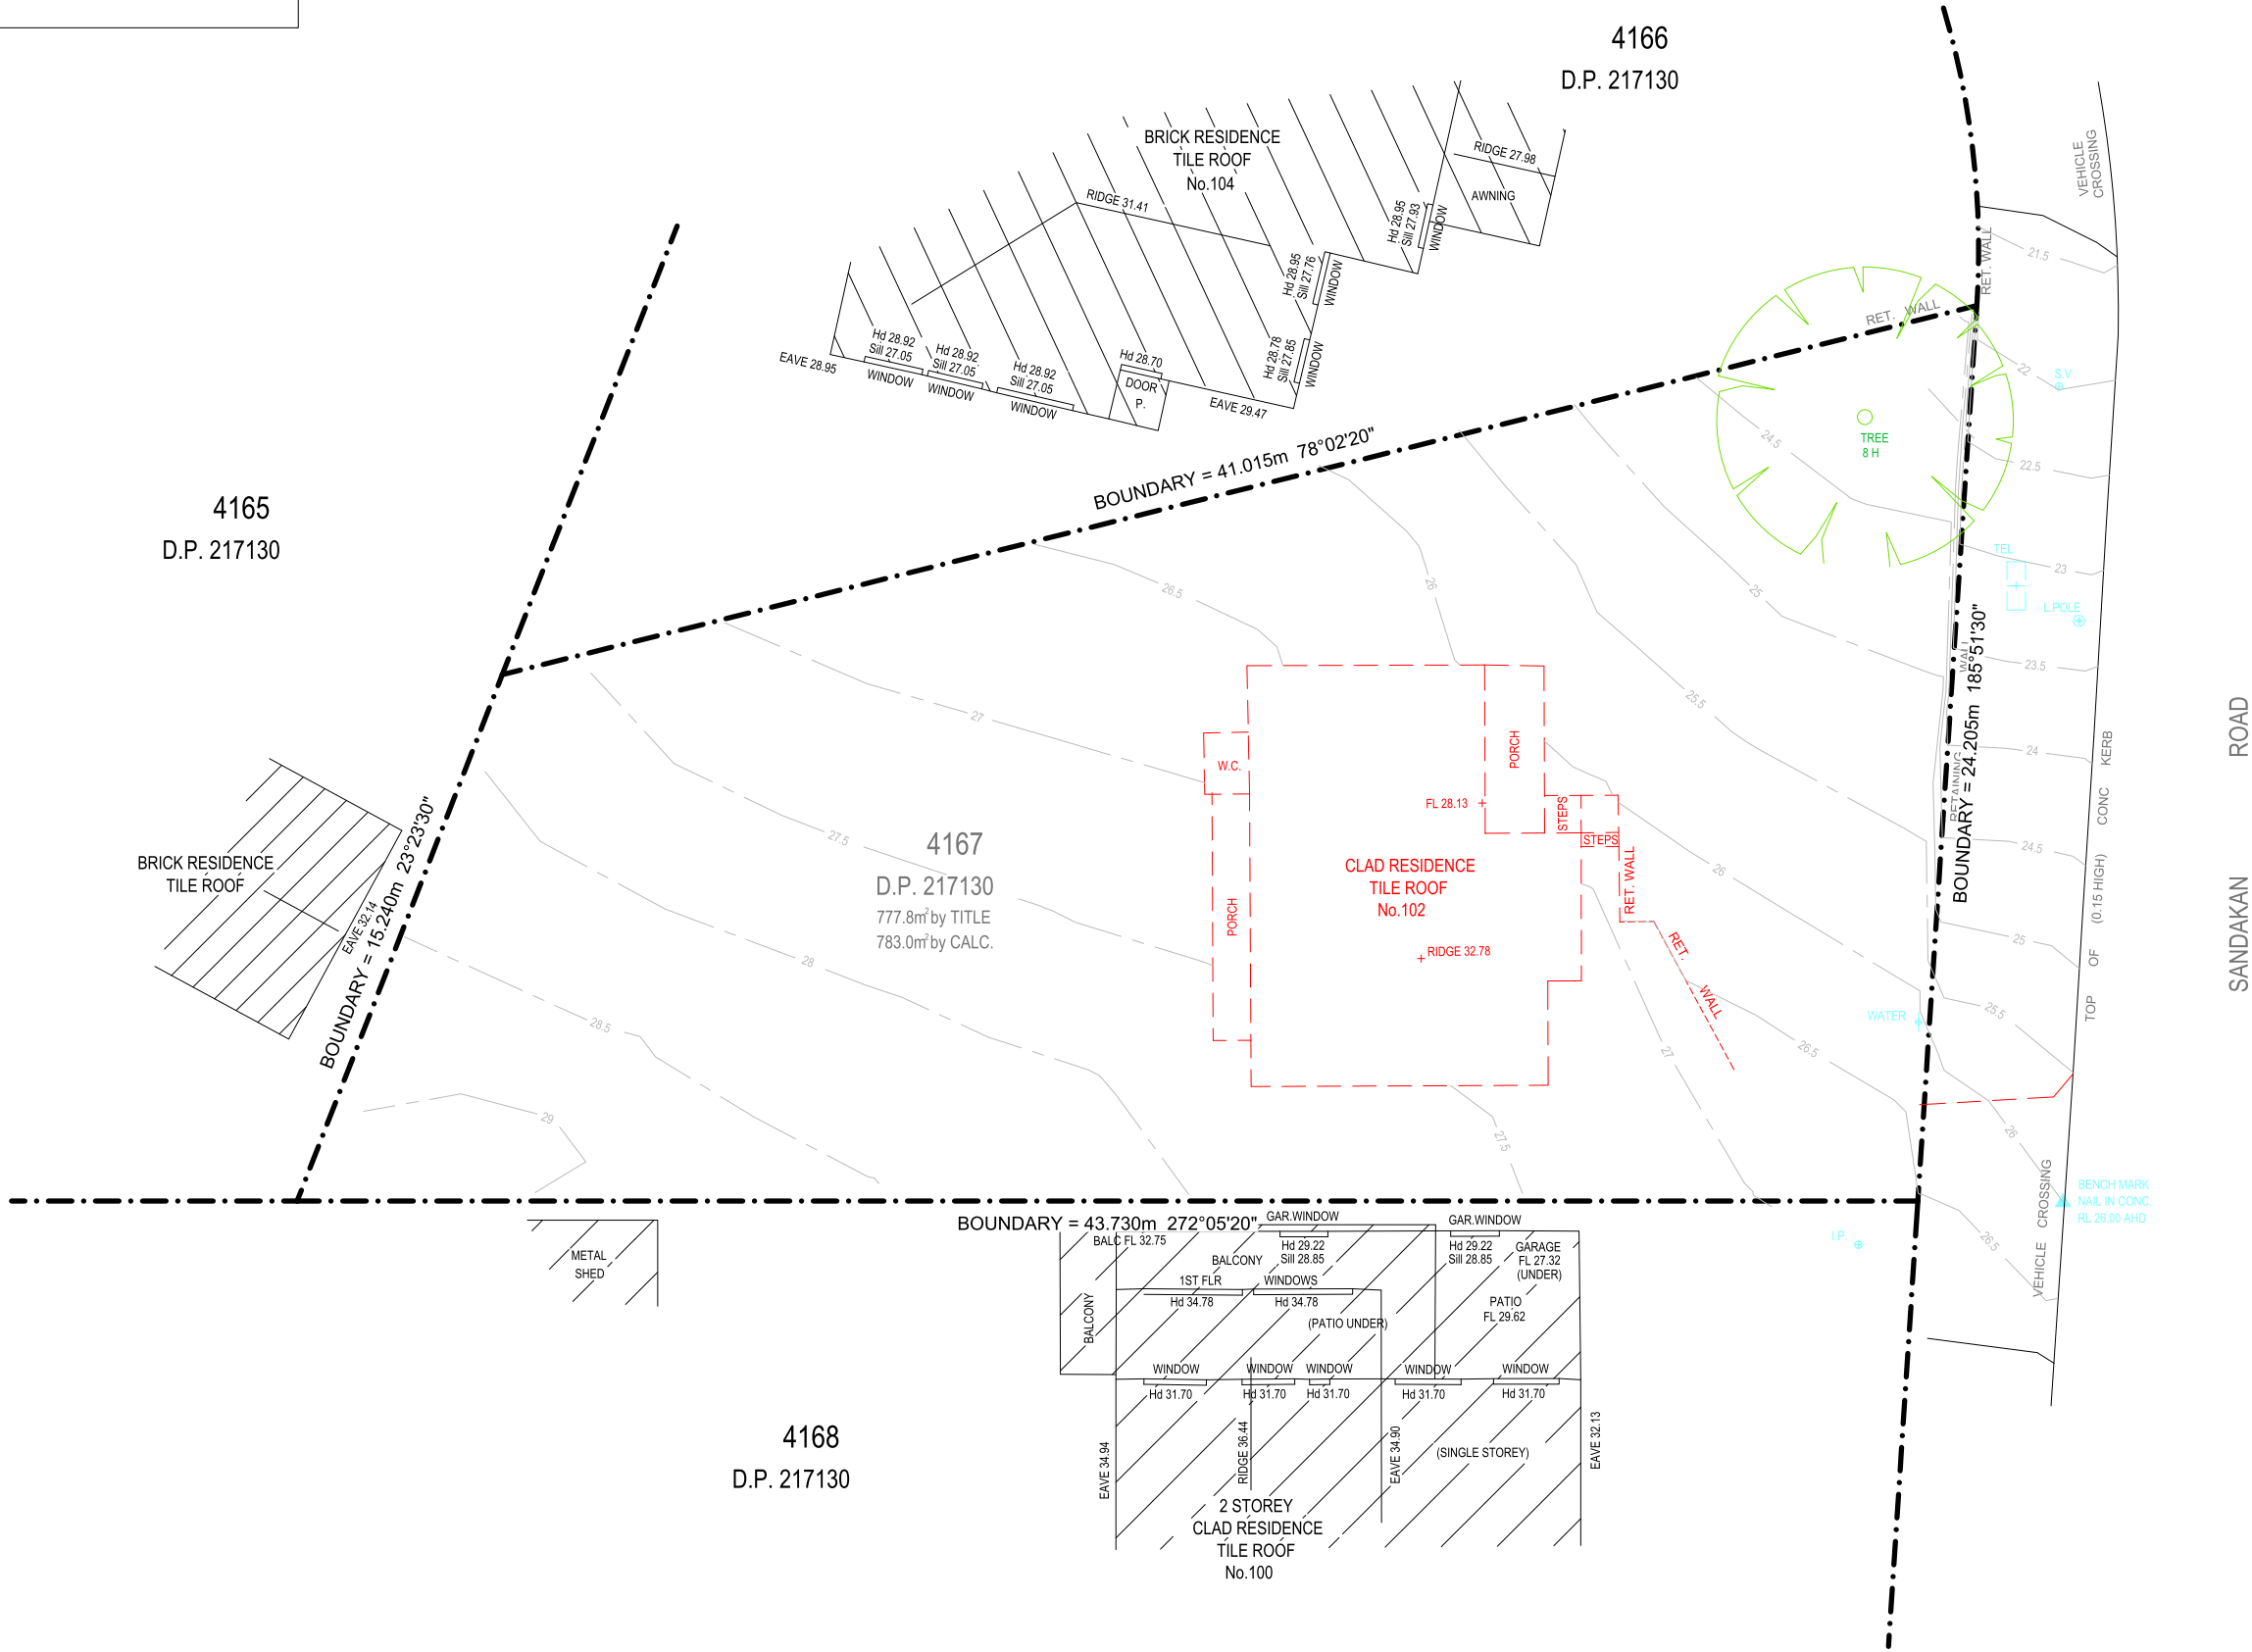

PROPOSED DEMOLITION PLAN
SCALE - 1 : 200



03	AS PER COUNCIL REQUIREMENTS	SK	04.11.2024
02	AS PER COUNCIL REQUIREMENTS	SK	04.07.2024
01	DEVELOPMENT APPLICATION	SK	11.04.2023
REV	AMENDMENT DETAILS	BY	DATE

PROJECT STAGE
DEVELOPMENT APP.

PROJECT DETAILS
DETACHED DUAL-OCC

**102 SANDAKAN ROAD,
REVESBY HEIGHTS**

CLIENT DETAILS
LIVINGSTON HOMES

DRAWING TITLE
**PROPOSED
DEMOLITION PLAN**

DRAWN
SK
DESIGNED
FB
CHECK
FB

DATE DRAWN
JULY 2024
DRAWING SCALE
1 : 200
SHEET SIZE
A3

0 1m 2m 3m 4m 5m 6m 7m 8m 9m 10m
X 1:100 @ A1 1:200 @ A3 1:267 @ A4



**ACCREDITED
BUILDING DESIGNER**

ACCREDITATION NUMBER: 6613 - MEMBER NUMBER 6763-21

PROJECT NUMBER
FB0077
DRAWING NUMBER
A.01.0
REVISION
03

SITE NOTES


- CONFIRM ALL DIMENSIONS ON SITE TO EXISTING RESIDENCE PRIOR TO COMMENCEMENT OF ANY WORK.
- EXISTING PLUMBING AND ELECTRICAL WORKS TO BE REMOVED AND MADE GOOD AS NECESSARY.
- THIS PLAN DOES NOT PROVIDE SPECIFIC LANDSCAPE PLANTING LOCATIONS.
- THE EXACT LOCATION OF UNDERGROUND AND ABOVEGROUND SERVICES SHALL BE PROVEN ON SITE. NO GUARANTEE IS GIVEN THAT ALL EXISTING SERVICES ARE SHOWN.
- THIS DRAWING SET TO BE READ IN CONJUNCTION WITH THE SPECIFICATION PROVIDED.
- BEWARE OF EXISTING SERVICES. CONFIRM LOCATIONS PRIOR TO EXCAVATION. TAKE EXTREME CARE.
- REFER ALL MAJOR WORKS TO RAMPS, WALKWAYS, DRIVEWAYS ETC (INCLUDING CARPARK WORKS, LEVELS & DATUMS) REFER TO CIVIL ENGINEERS DOCUMENTATION.

FEMME BUILD

NEW CONSTRUCTION
REMODELS
ADDITIONS
RENOVATIONS

0403 132 106
info@femmebuild.com.au

COPYRIGHT 2023 FEMME BUILD
REPRODUCTION OF THE WHOLE OR PART OF THIS DOCUMENT CONSTITUTES AND INFRINGES COPYRIGHT. THE INFORMATION, IDEAS AND CONCEPTS CONTAINED IN THIS DOCUMENT IS / ARE CONFIDENTIAL. THE RECIPIENT(S) OF THIS DOCUMENT IS / ARE PROHIBITED FROM DISCLOSING SUCH INFORMATION IDEAS AND CONCEPTS TO ANY PERSON WITHOUT PRIOR WRITTEN CONSENT OF THE COPYRIGHT HOLDER. CONTRACTOR TO CHECK AND VERIFY ALL LEVELS, DATUMS, A DIMENSIONS ON SITE AND SHALL REPORT ANY DISCREPANCIES OR OMISSIONS TO THE OFFICE PRIOR TO START OF WORK & DURING THE CONSTRUCTION PHASE. THIS DRAWING IS TO BE READ AND UNDERSTOOD IN CONJUNCTION WITH STRUCTURAL, MECHANICAL, ELECTRICAL AND OR ANY OTHER CONSULTANTS DOCUMENTATION AS MAY BE APPLICABLE TO THE PROJECT PRIOR TO START OF WORK & ITS DURATION. MEASUREMENT SCALING OF THIS DRAWING SHALL ONLY BE PERMITTED IN ITS DIGITAL FORM.

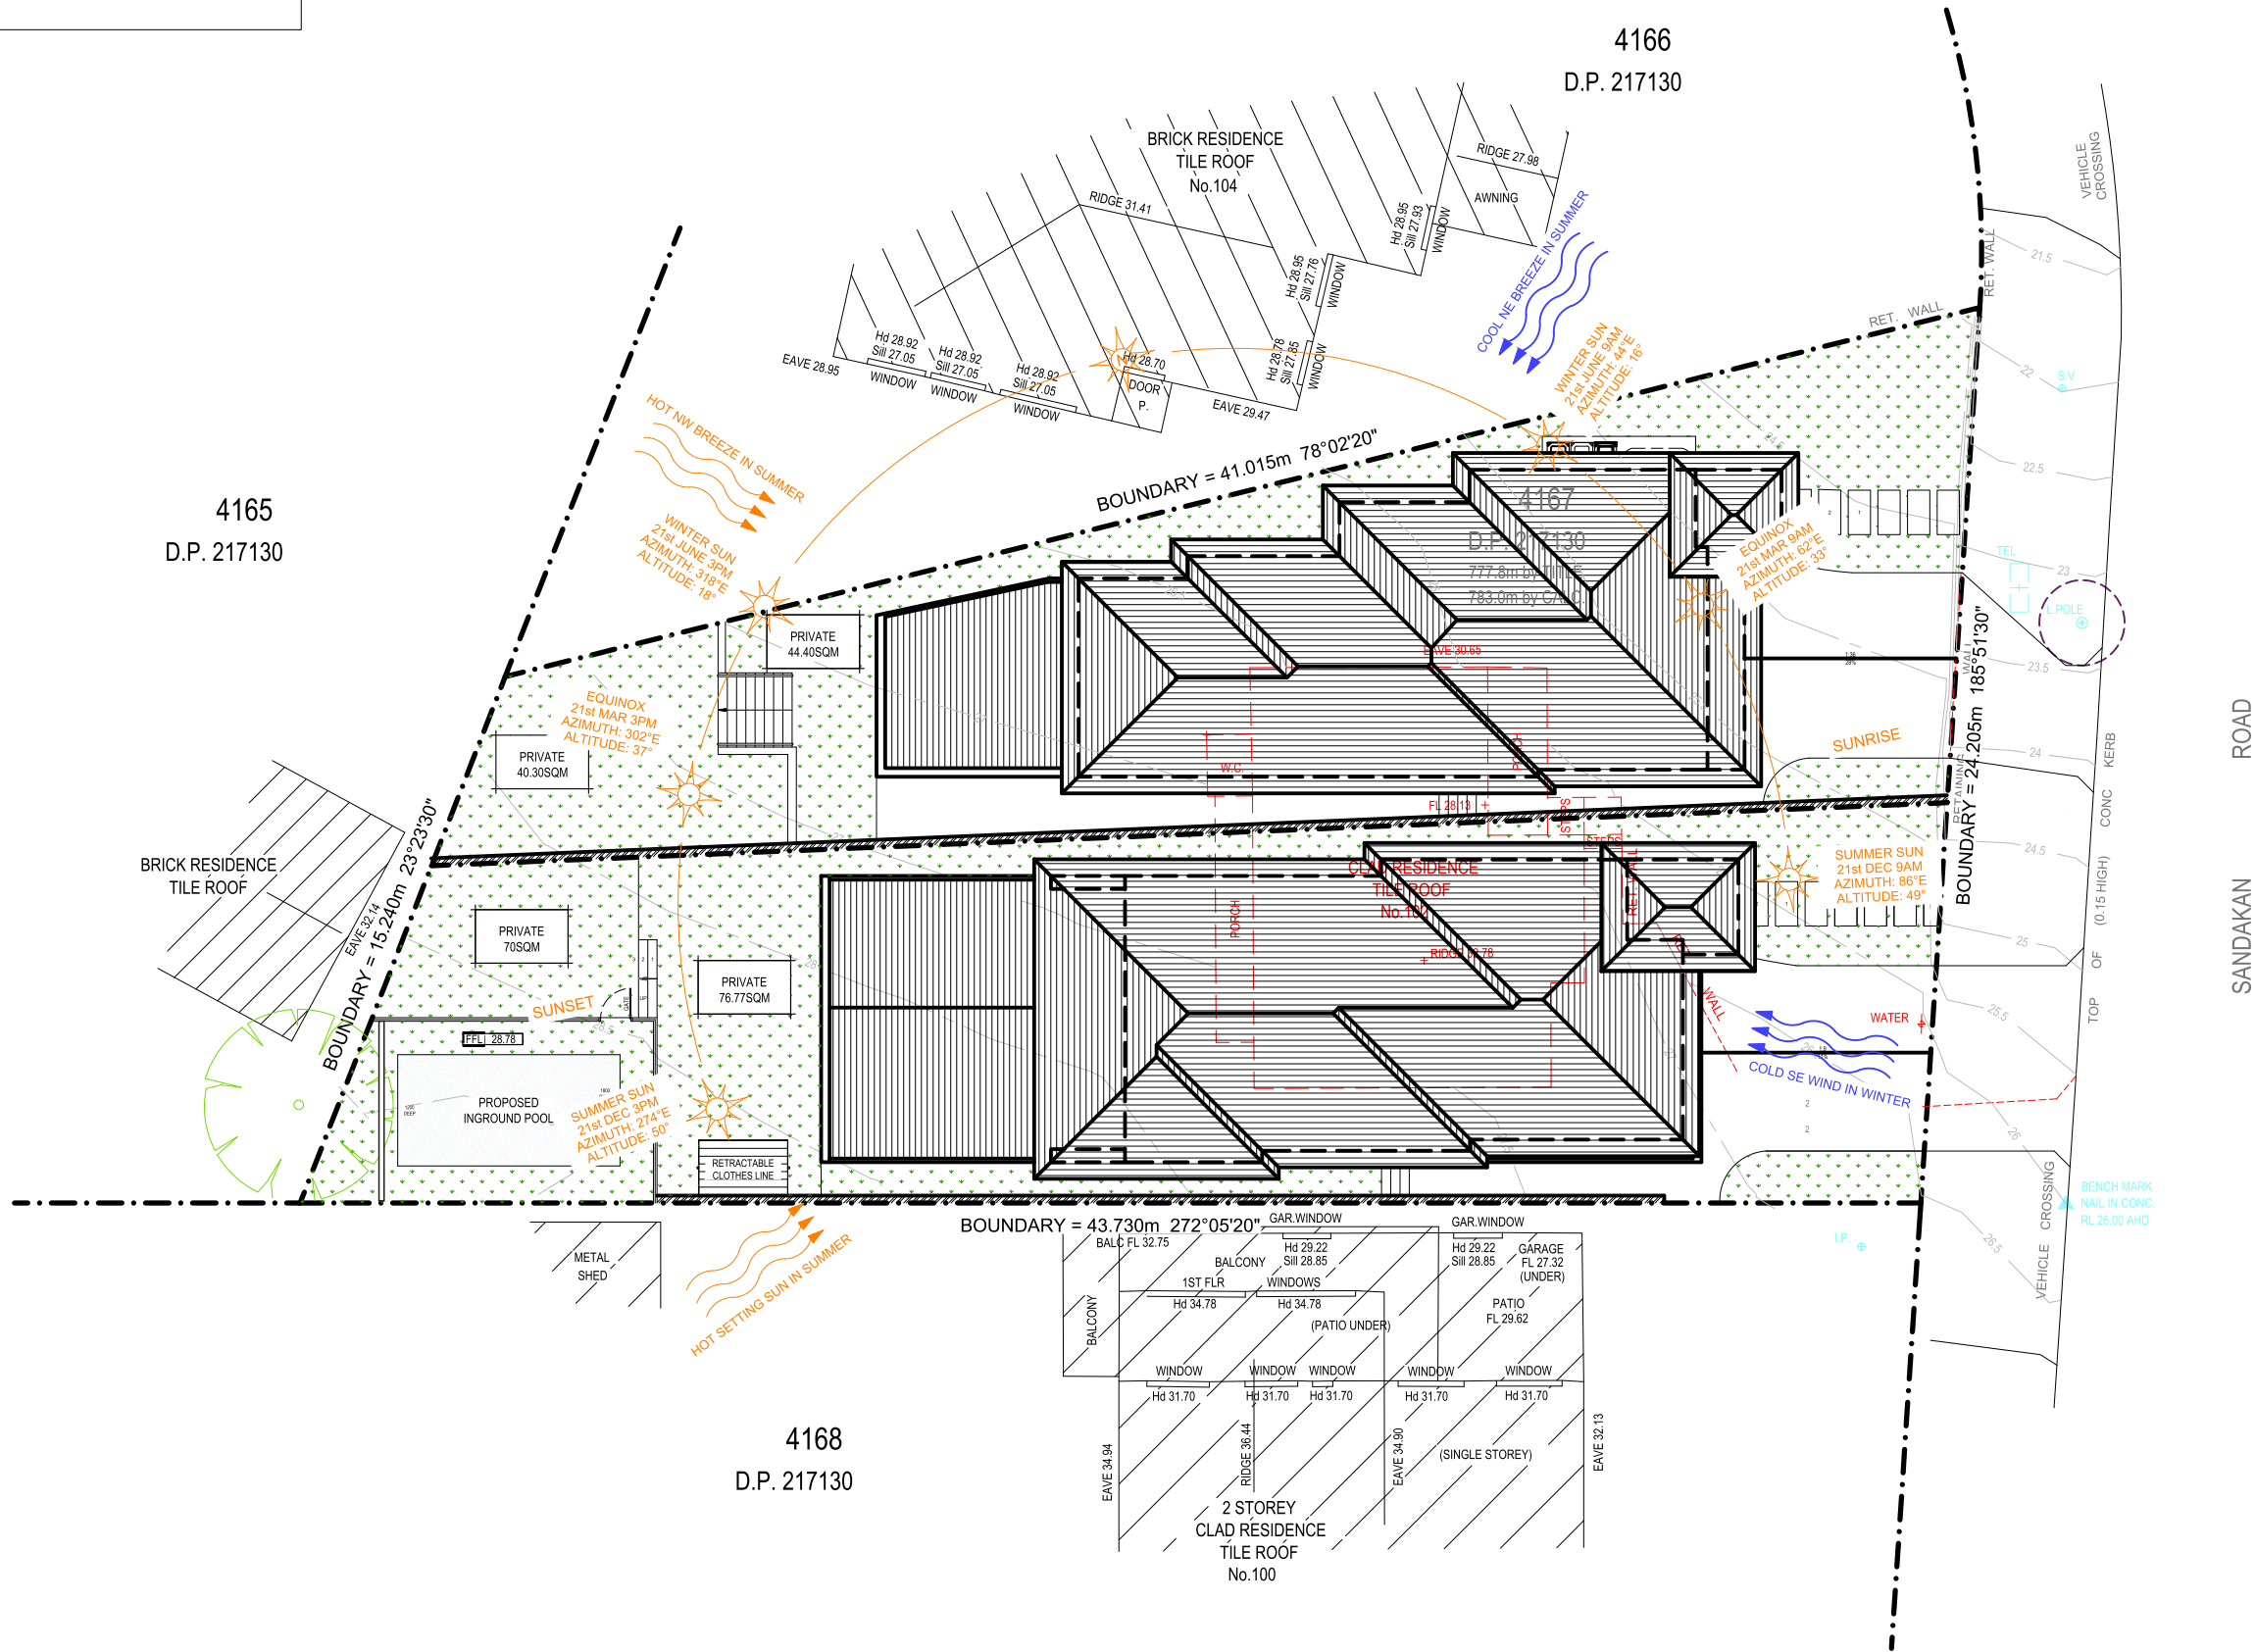

PROPOSED SITE ANALYSIS PLAN
SCALE - 1 : 200



03	AS PER COUNCIL REQUIREMENTS	SK	04.11.2024
02	AS PER COUNCIL REQUIREMENTS	SK	04.07.2024
01	DEVELOPMENT APPLICATION	SK	11.04.2023
REV	AMENDMENT DETAILS	BY	DATE

PROJECT STAGE
DEVELOPMENT APP.

PROJECT DETAILS
DETACHED DUAL-OCC

102 SANDAKAN ROAD,
REVESBY HEIGHTS

CLIENT DETAILS
LIVINGSTON HOMES

DRAWING TITLE
PROPOSED
SITE ANALYSIS PLAN

DRAWN
SK
DESIGNED
FB
CHECK
FB

DATE DRAWN
JULY 2024
DRAWING SCALE
1 : 200
SHEET SIZE
A3
0 1m 2m 3m 4m 5m 6m 7m 8m 9m 10m
X 1:100 @ A1 1:200 @ A3 1:267 @ A4



ACCREDITED
BUILDING DESIGNER

ACCREDITATION NUMBER: 6613 - MEMBER NUMBER 6763-21

PROJECT NUMBER
FB0077
DRAWING NUMBER
A.01.2
REVISION
03

1.5 M STAR PICKETS AT MAX. 2.5 M CENTRES

500 MM TO 800 MM

600 MM MIN.

SELF-SUPPORTING GEOTEXTILE

DIRECTION OF FLOW

150 MM X 100 MM TRENCH WITH COMPACTED BACKFILL AND ON ROCK, SE INTO SURFACE CONCRETE

SECTION DETAIL

DISTURBED AREA

UNDISTURBED AREA

DIRECTION OF FLOW

1.5 M STAR PICKETS AT MAX. 2.5 M CENTRES

20 M MAX. (UNLESS STATED OTHERWISE ON SW/SP/SCP)




FLOW

MIN. 1.5 M

STAR PICKETS AT MAXIMUM 2.5 M SPACINGS

PLAN

- CONSTRUCTION NOTES
- CONSTRUCT SEDIMENT FENCES AS CLOSE AS POSSIBLE TO BEING PARALLEL TO THE CONTOURS OF THE SITE, BUT WITH SMALL RETURNS AS SHOWN IN THE DRAWING TO LIMIT THE CATCHMENT AREA OF ANY ONE SECTION. THE CATCHMENT AREA SHOULD BE SMALL ENOUGH TO LIMIT WATER FLOW IF CONCENTRATED AT ONE POINT TO 50 LITRES PER SECOND IN THE DESIGN STORM EVENT. USUALLY THE 10-YEAR EVENT.
- CUT A 15-MM DEEP TRENCH ALONG THE UPSLOPE LINE OF THE FENCE FOR THE BOTTOM OF THE FABRIC TO BE ENRICHED.
- DRIVE 1.5 METRE LONG STAR PICKETS INTO GROUND AT 2.5 METRE INTERVALS (MAX) AT THE DOWNSLOPE SIDE OF THE TRENCH. ENSURE ANY STAR PICKETS ARE FITTED WITH SAFETY CAPS.
- USE SELF-SUPPORTING GEOTEXTILE TO THE UPSLOPE SIDE OF THE POSTS ENSURING IT COVERS TO THE BASE OF THE TRENCH. FIX THE GEOTEXTILE WITH IRON TIES OR AN EQUIVALENT BY THE MANUFACTURER. ONLY USE GEOTEXTILE SPECIFICALLY PRODUCED FOR SEDIMENT FENCING. THE USE OF SHADE CLOTH FOR THIS PURPOSE IS NOT SATISFACTORY.
- JOIN SECTIONS OF FABRIC AT A SUPPORT POST WITH A 15-MM OVERLAP.
- BACKFILL THE TRENCH OVER THE BASE OF THE FABRIC AND COMPACT IT THOROUGHLY OVER THE GEOTEXTILE.

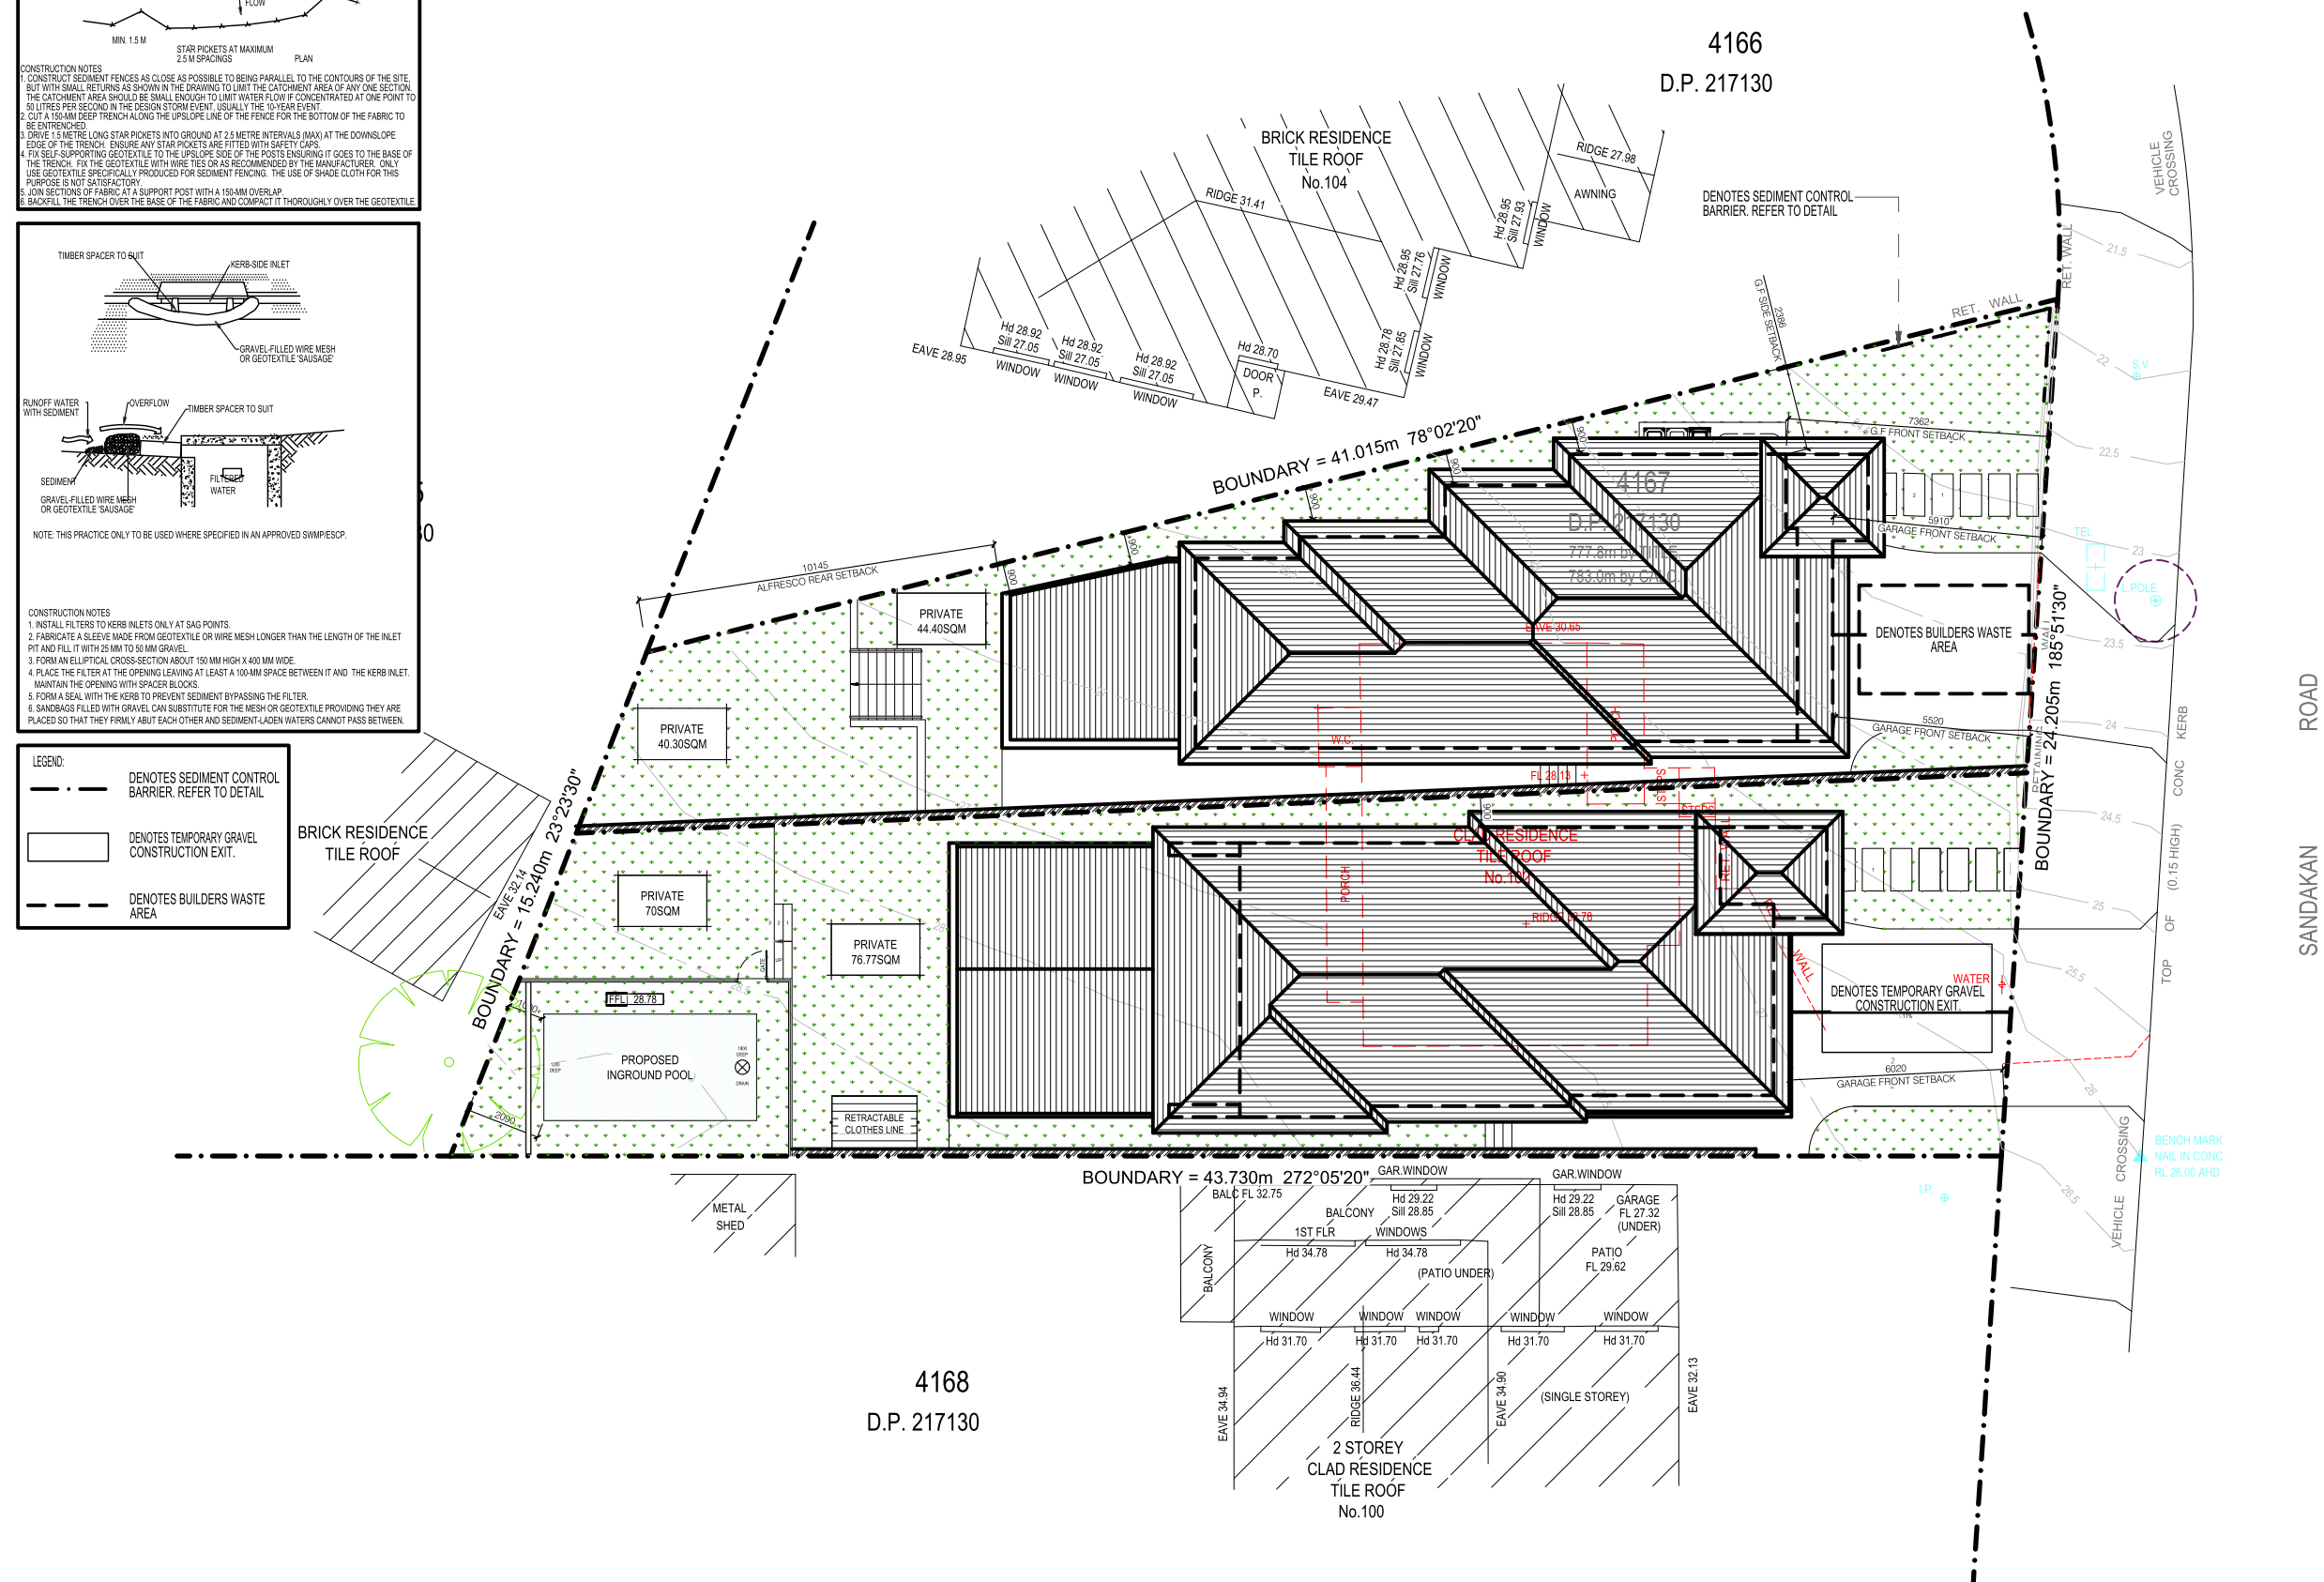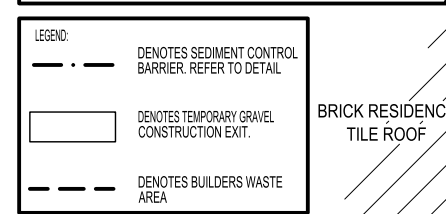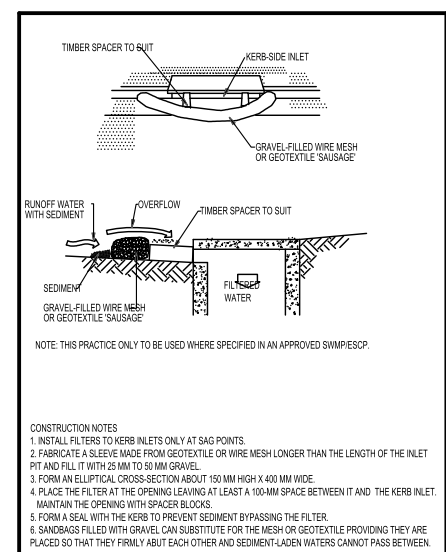

PROPOS
SCALE - 1 : 200

03	AS PER COUNCIL REQUIREMENTS	SK	04.11.2024
02	AS PER COUNCIL REQUIREMENTS	SK	04.07.2024
01	DEVELOPMENT APPLICATION	SK	11.04.2023
REV	AMENDMENT DETAILS	BY	DATE

PROJECT STAGE

DEVELOPMENT APP.

PROJECT DETAILS

DETACHED DUAL-OCC

102 SANDAKAN ROAD,
REVESBY HEIGHTS

CLIENT DETAILS

LIVINGSTON HOMES

DRAWING TITLE

PROPOSED SEDIMENT EROSION CONTROL PLAN

DRAWN
SK

DESIGNED 

FB 

CHECK
FB

DATE DRAWN
JULY 2024

DRAWING SCALE
1 : 200

SHEET SIZE
A3



ACCREDITATION NUMBER: 6613 • MEMBER NUMBER 6763-21


PROJECT NUMBER	DRAWING NUMBER	REVISION
FB0077	A.01.4	03

SITE INFORMATION

SITE AREA	783m² (BY CALC)
UNIT 1	
PROPOSED SITE AREA	417m²
PROPOSED RESIDENCE G. FLOOR	102.77m²
GARAGE	30.34m²
ALFRESCO	29.85m²
PROPOSED RESIDENCE F.FLOOR	89.83m²
BALCONIES	6.48m²
TOTAL FLOOR AREA	192.60m²
UNIT 2	
PROPOSED SITE AREA	366m²
PROPOSED RESIDENCE G. FLOOR	88.45m²
GARAGE	30.34m²
ALFRESCO	17.29m²
PROPOSED RESIDENCE F.FLOOR	94.55m²
BALCONIES	11.19m²
TOTAL FLOOR AREA	184.10m²
FLOOR SPACE RATIO	0.5:1
PERMEABILITY	267.35m²(34%)
PRIVATE OPEN SPACE (POS)	84.70m²(MIN)
MAX BUILDING HEIGHT	8.2m

SITE NOTES

- CONFIRM ALL DIMENSIONS ON SITE TO EXISTING RESIDENCE PRIOR TO COMMENCEMENT OF ANY WORK.
- EXISTING PLUMBING AND ELECTRICAL WORKS TO BE REMOVED AND MADE GOOD AS NECESSARY.
- THIS PLAN DOES NOT PROVIDE SPECIFIC LANDSCAPE PLANTING LOCATIONS.
- THE EXACT LOCATION OF UNDERGROUND AND ABOVEGROUND SERVICES SHALL BE PROVEN ON SITE. NO GUARANTEE IS GIVEN THAT ALL EXISTING SERVICES ARE SHOWN.
- THIS DRAWING SET TO BE READ IN CONJUNCTION WITH THE SPECIFICATION PROVIDED.
- BEWARE OF EXISTING SERVICES. CONFIRM LOCATIONS PRIOR TO EXCAVATION. TAKE EXTREME CARE.
- REFER ALL MAJOR WORKS TO RAMPS, WALKWAYS, DRIVEWAYS ETC (INCLUDING CARPARK WORKS, LEVELS & DATUMS) REFER TO CIVIL ENGINEERS DOCUMENTATION.

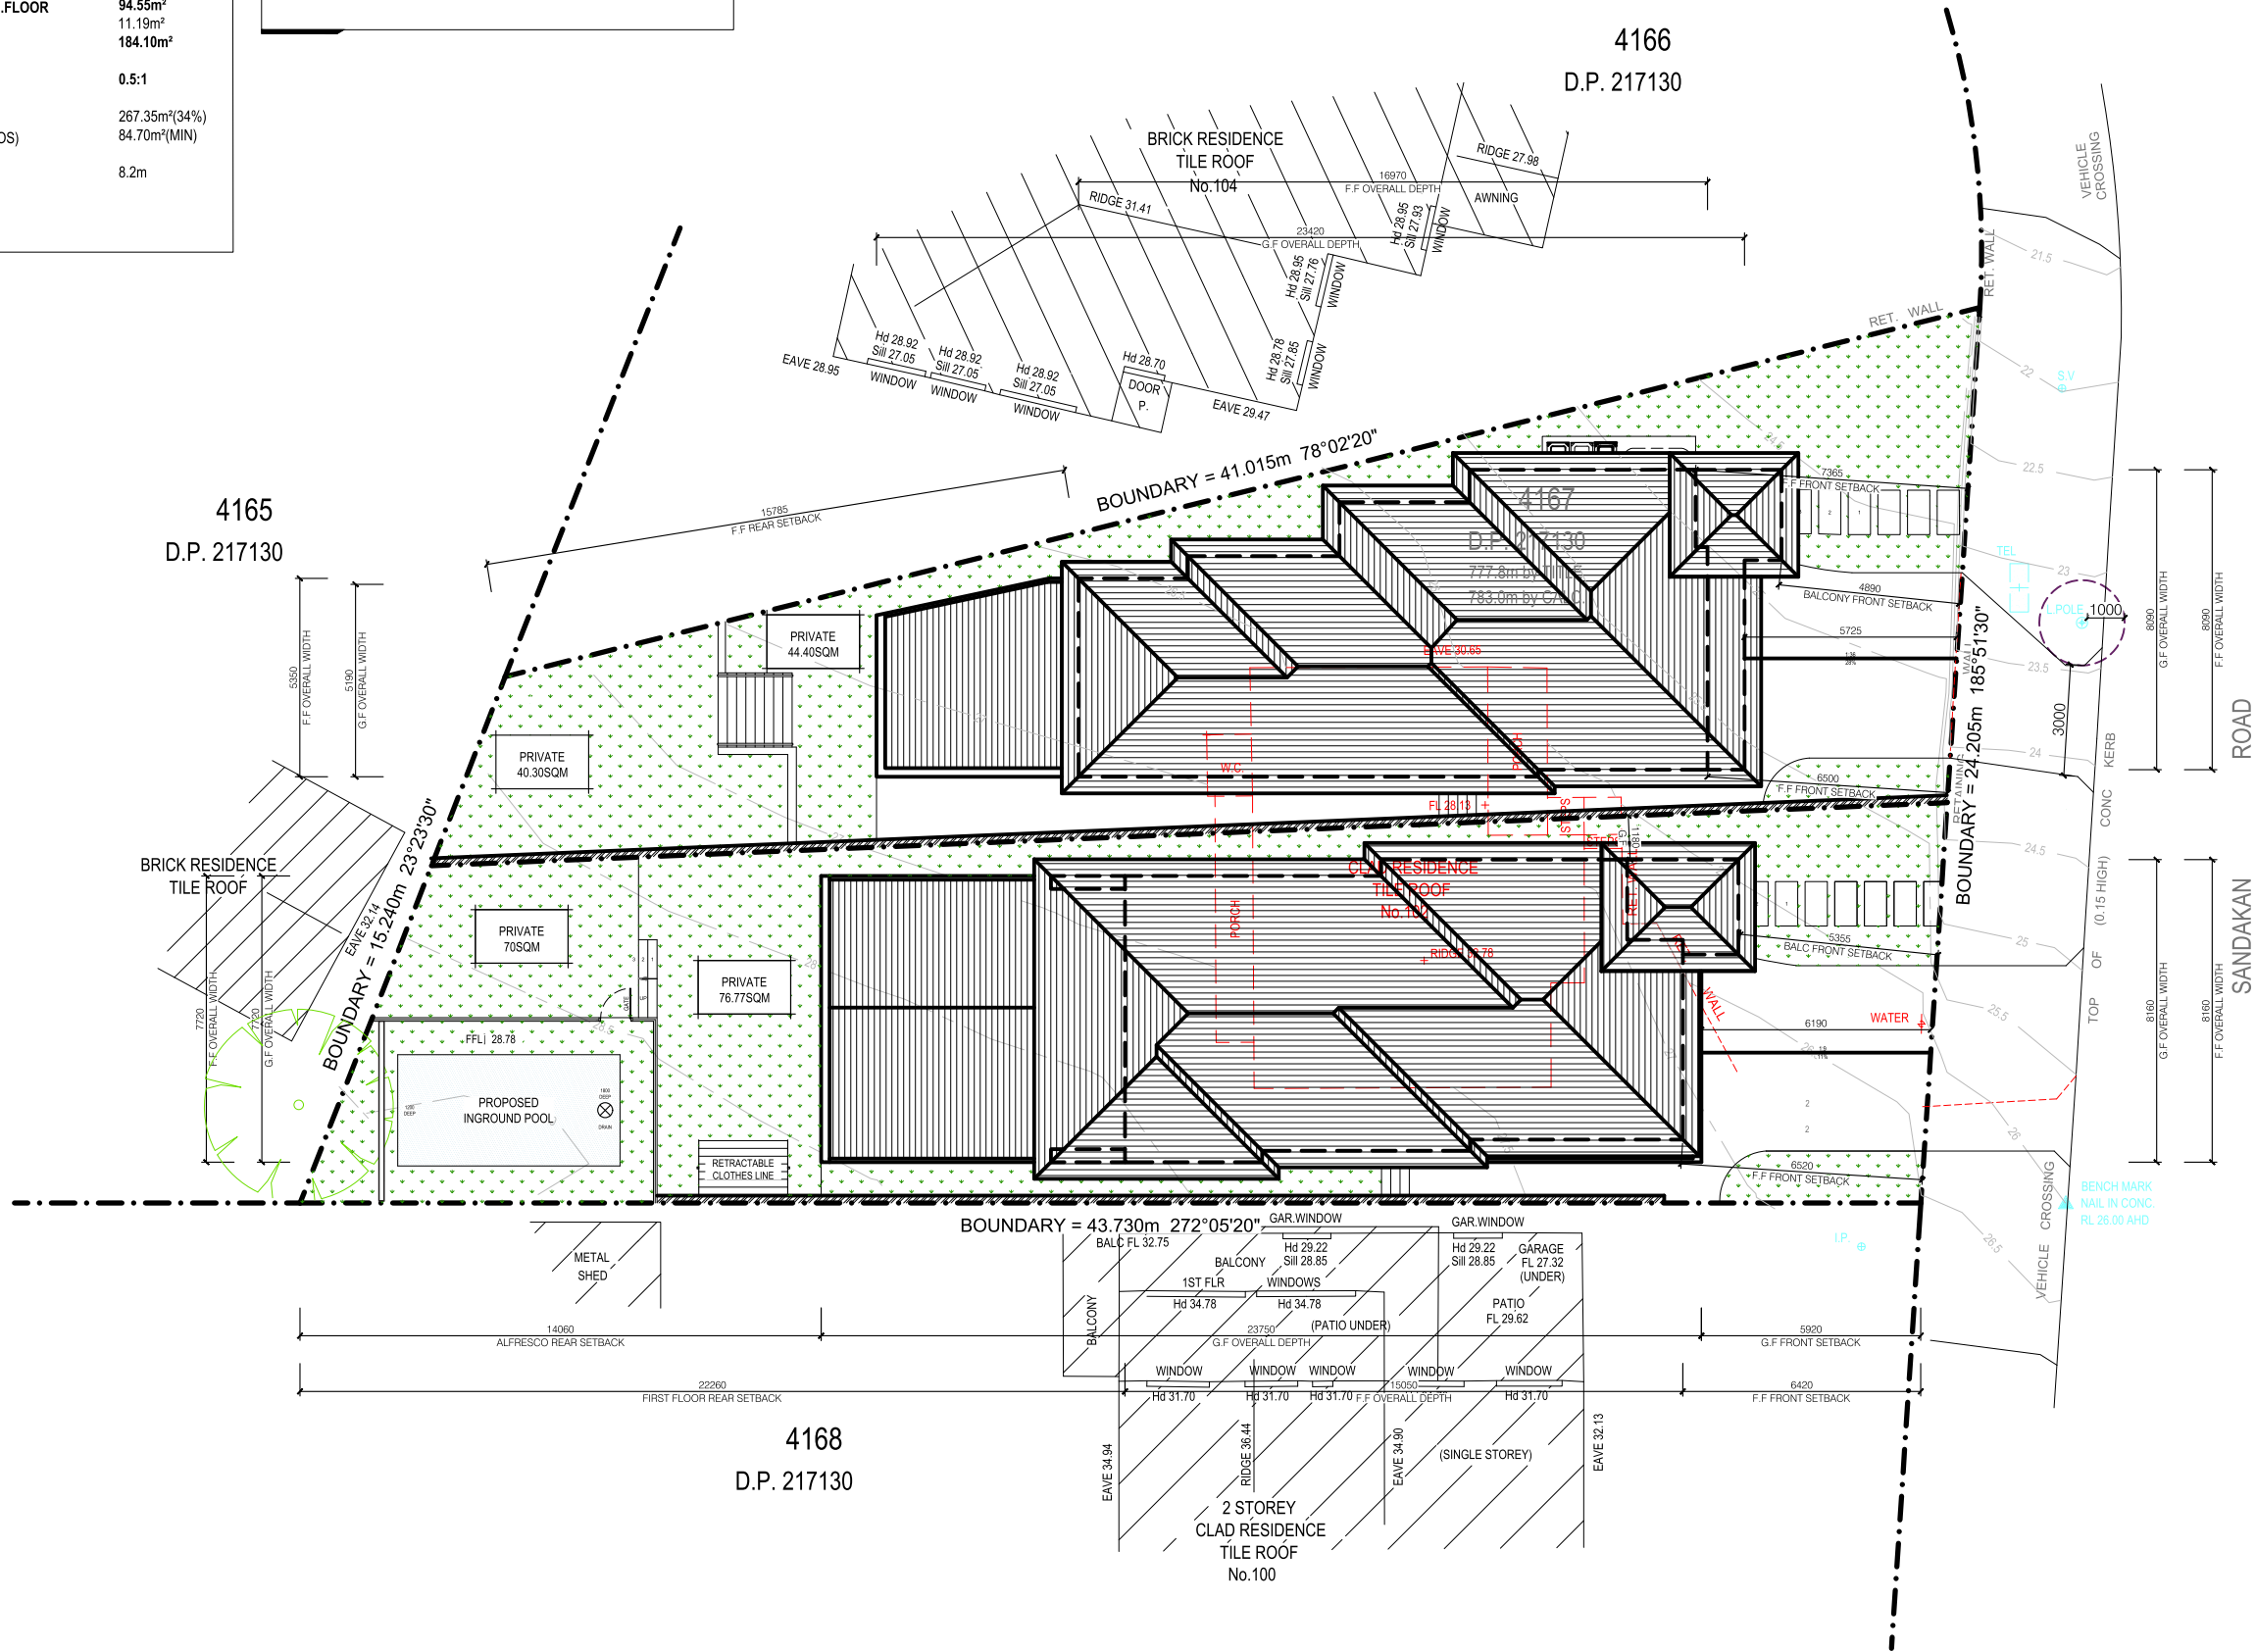


FEMME BUILD

NEW CONSTRUCTION
REMODELS
ADDITIONS
RENOVATIONS

0403 132 106
info@femmebuild.com.au

COPYRIGHT 2023 FEMME BUILD
REPRODUCTION OF THE WHOLE OR PART OF THIS DOCUMENT CONSTITUTES AND INFRINGES COPYRIGHT. THE INFORMATION, IDEAS AND CONCEPTS CONTAINED IN THIS DOCUMENT IS/ARE CONFIDENTIAL. THE RECIPIENT(S) OF THIS DOCUMENT IS/ARE PROHIBITED FROM DISCLOSING SUCH INFORMATION IDEAS AND CONCEPTS TO ANY PERSON WITHOUT PRIOR WRITTEN CONSENT OF THE COPYRIGHT HOLDER. CONTRACTOR TO CHECK AND VERIFY ALL LEVELS, DATUMS, A DIMENSIONS ON SITE AND SHALL REPORT ANY DISCREPANCIES OR OMISSIONS TO THIS OFFICE PRIOR TO START OF WORK & DURING THE CONSTRUCTION PHASE. THIS DRAWING IS TO BE READ AND UNDERSTOOD IN CONJUNCTION WITH STRUCTURAL, MECHANICAL, ELECTRICAL AND/OR ANY OTHER CONSULTANTS DOCUMENTATION AS MAY BE APPLICABLE TO THE PROJECT PRIOR TO START OF WORK & ITS DURATION. MEASUREMENT SCALING OF THIS DRAWING SHALL ONLY BE PERMITTED IN ITS DIGITAL FORM.

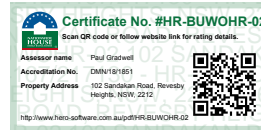

03	AS PER COUNCIL REQUIREMENTS	SK	04.11.2024
02	AS PER COUNCIL REQUIREMENTS	SK	04.07.2024
01	DEVELOPMENT APPLICATION	SK	11.04.2023
REV	AMENDMENT DETAILS	BY	DATE

PROJECT STAGE
DEVELOPMENT APP.

PROJECT DETAILS
DETACHED DUAL-OCC

102 SANDAKAN ROAD,
REVESBY HEIGHTS

CLIENT DETAILS
LIVINGSTON HOMES

DRAWING TITLE
PROPOSED
SITE PLAN

DRAWN
SK

DESIGNED
FB

CHECK
FB

DATE DRAWN
JULY 2024

DRAWING SCALE
1 : 200

SHEET SIZE
A3

0 1m 2m 3m 4m 5m 6m 7m 8m 9m 10m
X 1:100 @ A1 1:200 @ A3 1:267 @ A4



ACCREDITED
BUILDING DESIGNER

ACCREDITATION NUMBER: 6613 - MEMBER NUMBER 6763-21

PROJECT NUMBER FB0077	DRAWING NUMBER A.01.1	REVISION 03
--------------------------	--------------------------	----------------

PROPOSED SITE PLAN
SCALE - 1 : 200

SPECIFICATIONS

1. EARTHWORKS:
REMOVE ALL BUILDERS MATERIAL. CULTIVATE GARDENS TO A DEPTH OF 200mm. COVER WITH SOIL SUITABLE FOR GENERAL LANDSCAPING RECYCLED PRODUCTS SUCH AS ANL's NITRO GARDEN MIX, GREEN LIFE MIX etc.

2. GARDEN EDGE:
USE SELECTED PAVES LAID ON CONCRETE FOOTING. PAVES TO BE LAID EVENLY IN STRUCTURE BOND, 10mm JOINTS.

3. PLANTS:
TO BE TRUE TO FORM, FREE FROM DISEASE AND WELL DEVELOPED.

4. MULCH:
USE MULCH THAT MEETS AS4454, 75mm THICH (FOREST BLEND-coarse)

5. DRAINAGE:
REFER TO HYDRAULIC ENGINEERS REPORT.

6. FENCING:
BOUNDARY AND COURTYARD, 1800mm HIGH FENCE.

7. PAVING:
SELECTED HARD PAVING.

8. SUPPORT:
TRELLIS, LATTICE OR WIRE TO BE PUT ON THE FENCE.

LANDSCAPE MAINTENANCE

1. MAINTAIN THE ORIGINAL CHARACTER OF PLANTINGS:
REPLACEMENT OR ADDITIONAL PLANTINGS SHOULD BE CHOSEN FROM THE RANGE OF SPECIES ORIGINALLY PLANTED OR FROM PLANTS SIMILAR IN FORM AND CHARACTER.


2. STRUCTURES:
ORIGINAL GARDEN STRUCTURES, WALLS AND EDGES, SHOULD BE CONSERVED IN THEIR ORIGINAL LOCATIONS AND SHOULD BE REGULARLY CLEANED AND MAINTAINED.

3. VIEWS AND VISTAS:
TO MAINTAIN SIGNIFICANT VIEWS, PRUNE PLANTING AS NECESSARY, BUT NOT BEYOND 20% OF THE CROWN PRUNING OF LARGE TREES SHOULD ONLY BE UNDERTAKEN BY QUALIFIED TREE SURGEON OR ARBORIST.

4. CARE OF LAWNS:
A HEALTH VIGOROUS SWARD OF GRASS IS THE BEST DEFENSE AGAINST PESTS, DISEASE AND WEEDS. GRASS REQUIRES INTENSIVE AND CONTINUAL MAINTENANCE THROUGHOUT THE YEAR INCLUDING MOWING, WATERING, AERATING, FERTILIZING, WEEDING AND CONTROL OF PESTS AND DISEASES.






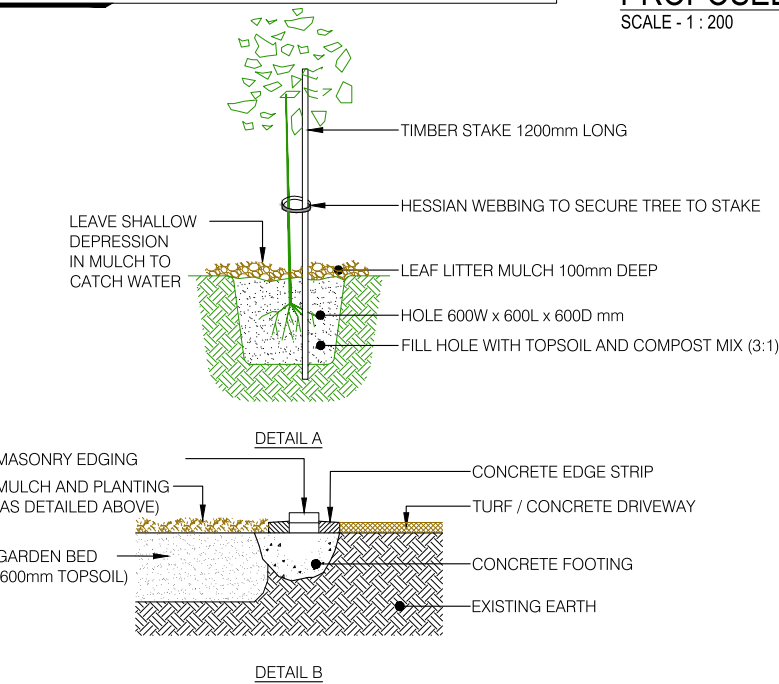



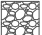

5. CARE OF TREES AND SHRUBS:


- CONTROL SIZE
- IMPROVE SHAPE, FLOWERING AND FRUITING
- REMOVE DISEASED, DEAD AND DANGEROUS MATERIALS.



PROPOSED LANDSCAPE PLAN

SCALE - 1 : 200

SITE INFORMATION		PLANT SCHEDULE				
	PEBBLES	<div>SYMBOL</div> <div></div> <div></div> <div></div> <div></div>	<div>BOTANICAL NAME</div> <div>TLI - LAGERSTROEMIA INDICA 'CREPEMYRTL'</div> <div>CORDYLINE FRUTICOSA RUBRA</div> <div>ALPINIA ZERUMBET VARIEGATA</div> <div>WG - WATER GUM LUSCIOUS TRISTANIOPSIS LAURINA</div>	<div>MATURE HEIGHT</div> <div>4m - 6m</div> <div>1.5m</div> <div>1.5m</div> <div>8m</div>	<div>PURCHASE SIZE</div> <div>75Ltr</div> <div>0.3mm</div> <div>0.2mm</div> <div>75Ltr</div>	<div>QUANTITY</div> <div>1</div> <div>10</div> <div>/</div> <div>1</div>
	LAWN AREA					
	PAVED					
	SCREEN PLANTING					
	DEEP SOIL ZONE					
	INTEGRATED INDOOR / OUTDOOR LIVING					
	SHADE TREE					

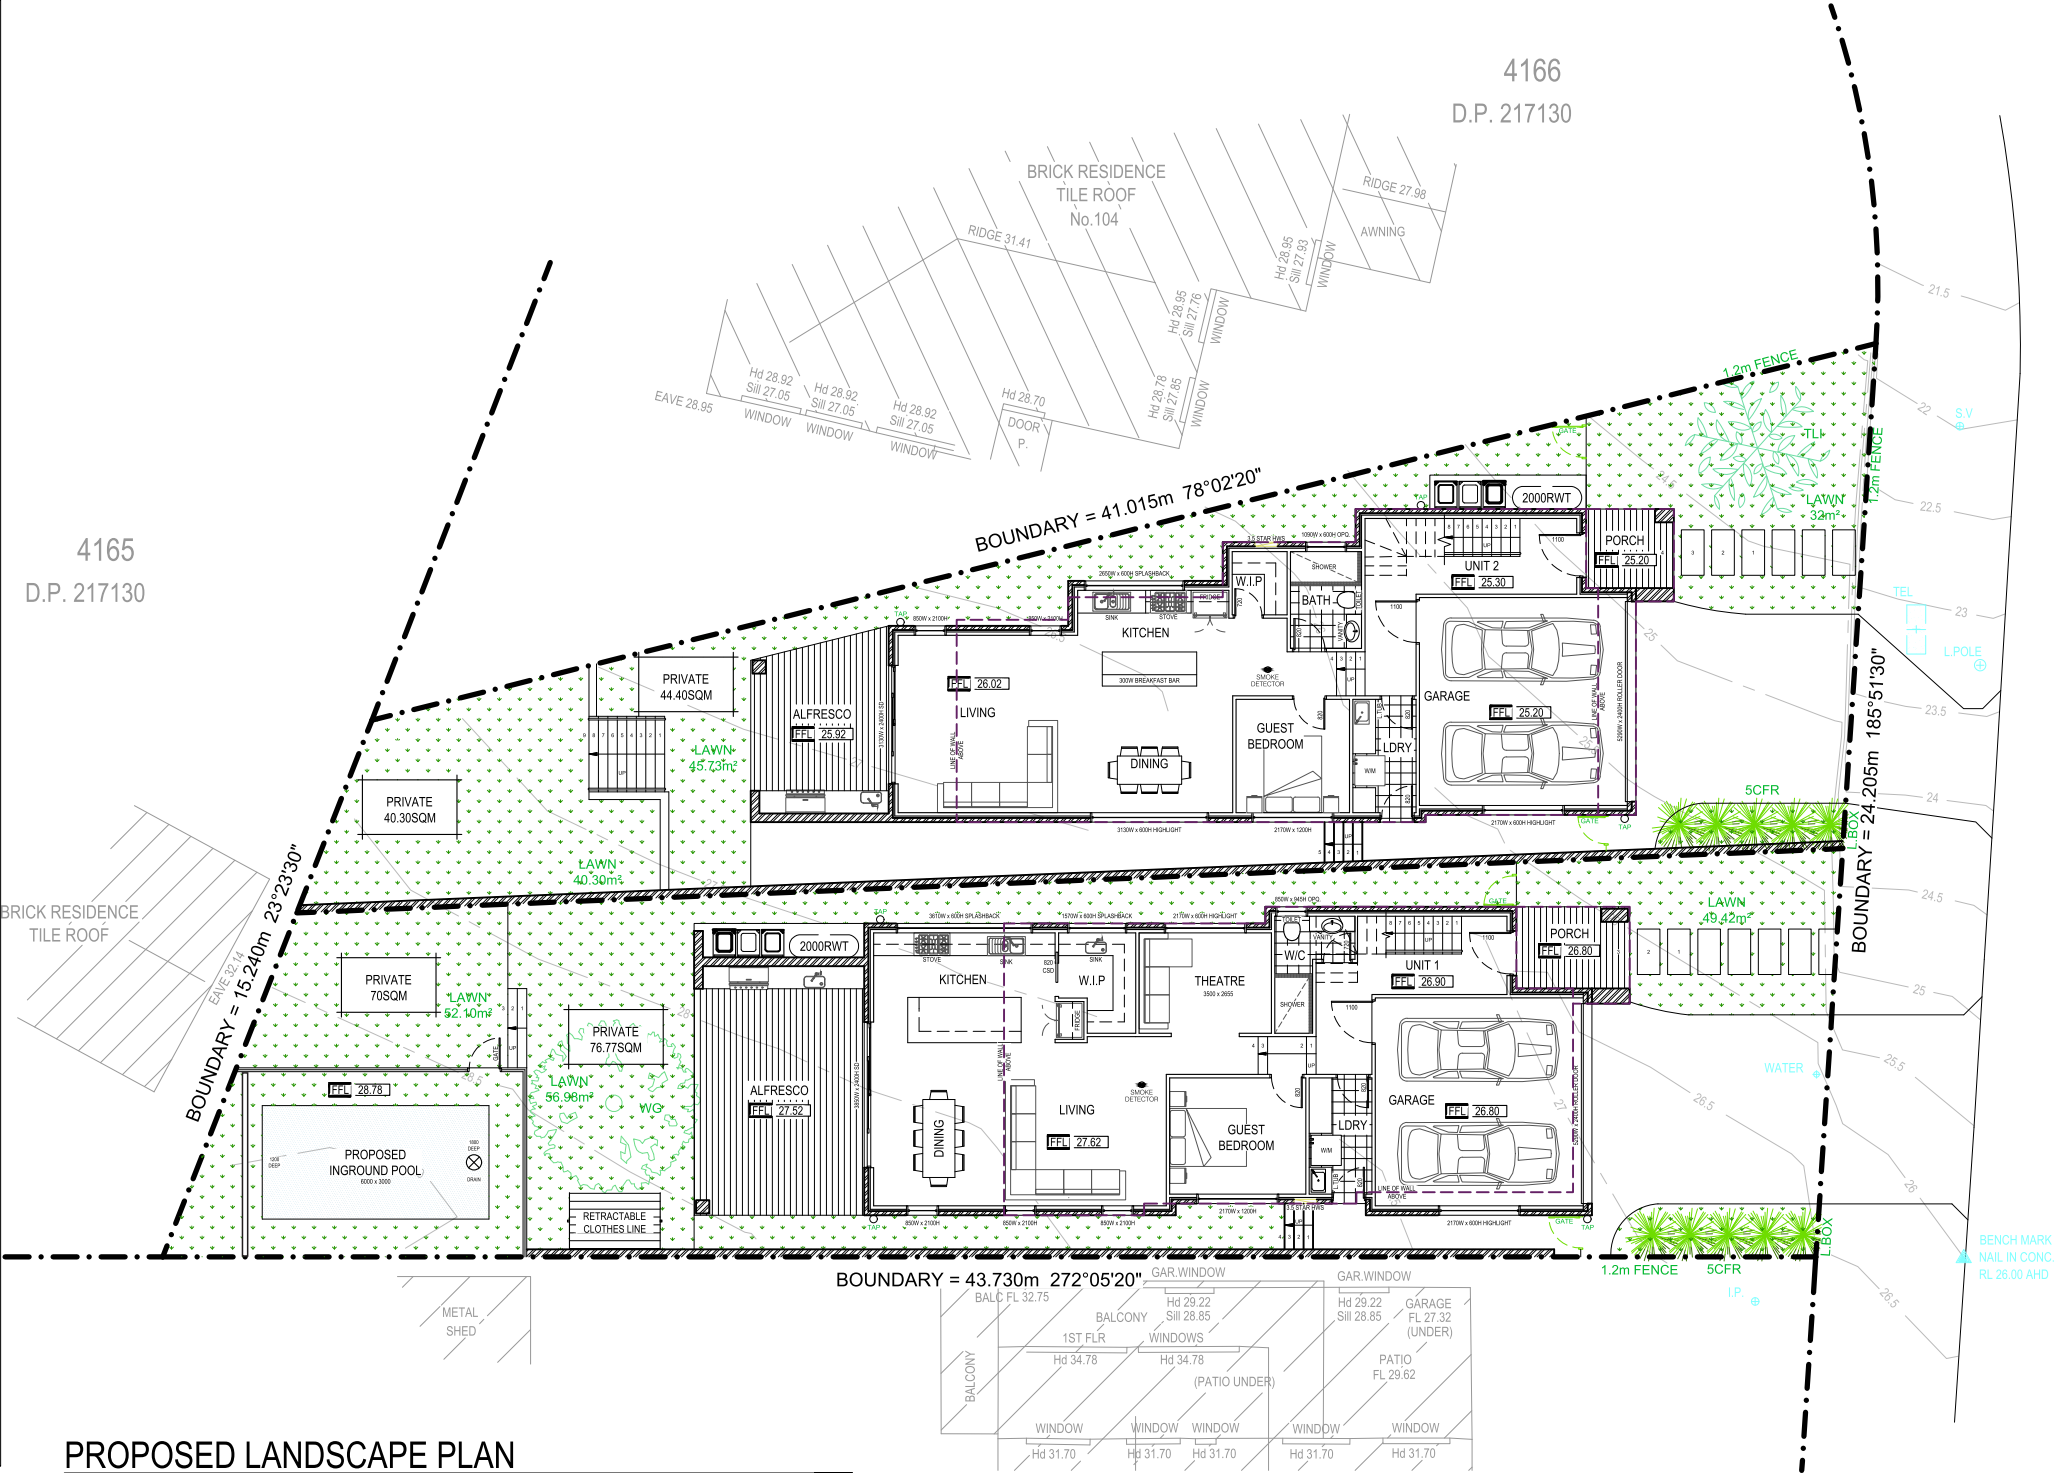

FEMME BUILD

NEW CONSTRUCTION
REMODELS
ADDITIONS
RENOVATIONS

0403 132 106
info@femmebuild.com.au

COPYRIGHT 2023 FEMME BUILD
REPRODUCTION OF THE WHOLE OR PART OF THIS DOCUMENT CONSTITUTES AND INFRINGES COPYRIGHT. THE INFORMATION, IDEAS AND CONCEPTS CONTAINED IN THIS DOCUMENT IS / ARE CONFIDENTIAL. THE RECIPIENT(S) OF THIS DOCUMENT IS / ARE PROHIBITED FROM DISCLOSING SUCH INFORMATION IDEAS AND CONCEPTS TO ANY PERSON WITHOUT PRIOR WRITTEN CONSENT OF THE COPYRIGHT HOLDER. CONTRACTOR TO CHECK AND VERIFY ALL LEVELS, DATUMS, A DIMENSIONS ON SITE AND SHALL REPORT ANY DISCREPANCIES OR OMISSIONS TO THIS OFFICE PRIOR TO START OF WORK DURING THE CONSTRUCTION PHASE. THIS DRAWING IS TO BE READ AND UNDERSTOOD IN CONJUNCTION WITH STRUCTURAL, MECHANICAL, ELECTRICAL AND OR ANY OTHER CONSULTANTS DOCUMENTATION AS MAY BE APPLICABLE TO THE PROJECT PRIOR TO START OF WORK. ITS DURATION, MEASUREMENT, SCALING OF THIS DRAWING SHALL ONLY BE PERMITTED IN ITS DIGITAL FORM.

ROAD

SANDAKAN

03	AS PER COUNCIL REQUIREMENTS	SK	04.11.2024
02	AS PER COUNCIL REQUIREMENTS	SK	04.07.2024
01	DEVELOPMENT APPLICATION	SK	11.04.2023
REV	AMENDMENT DETAILS	BY	DATE

PROJECT STAGE
DEVELOPMENT APP.

PROJECT DETAILS
DETACHED DUAL-OCC

102 SANDAKAN ROAD,
REVESBY HEIGHTS

CLIENT DETAILS
LIVINGSTON HOMES

DRAWING TITLE
**PROPOSED
LANDSCAPE PLAN**

DRAWN SK	
DESIGNED FB	
CHECK FB	
DATE DRAWN JULY 2024	
DRAWING SCALE 1 : 200	SHEET SIZE A3
0 1m 2m 3m 4m 5m 6m 7m 8m 9m 10m	
X 1:100 @ A1 1:200 @ A3 1:267 @ A4	

bdca
**ACCREDITED
BUILDING DESIGNER**

ACCREDITATION NUMBER: 6613 - MEMBER NUMBER 6763-21

PROJECT NUMBER FB0077	DRAWING NUMBER A.01.5	REVISION 03
--------------------------	--------------------------	----------------

SITE NOTES


- CONFIRM ALL DIMENSIONS ON SITE TO EXISTING RESIDENCE PRIOR TO COMMENCEMENT OF ANY WORK.
- EXISTING PLUMBING AND ELECTRICAL WORKS TO BE REMOVED AND MADE GOOD AS NECESSARY.
- THIS PLAN DOES NOT PROVIDE SPECIFIC LANDSCAPE PLANTING LOCATIONS.
- THE EXACT LOCATION OF UNDERGROUND AND ABOVEGROUND SERVICES SHALL BE PROVEN ON SITE. NO GUARANTEE IS GIVEN THAT ALL EXISTING SERVICES ARE SHOWN.
- THIS DRAWING SET TO BE READ IN CONJUNCTION WITH THE SPECIFICATION PROVIDED.
- BEWARE OF EXISTING SERVICES. CONFIRM LOCATIONS PRIOR TO EXCAVATION. TAKE EXTREME CARE.
- REFER ALL MAJOR WORKS TO RAMPS, WALKWAYS, DRIVEWAYS ETC (INCLUDING CARPARK WORKS, LEVELS & DATUMS) REFER TO CIVIL ENGINEERS DOCUMENTATION.

FEMME BUILD

NEW CONSTRUCTION
REMODELS
ADDITIONS
RENOVATIONS

0403 132 106
info@femmebuild.com.au

COPYRIGHT 2023 FEMME BUILD
REPRODUCTION OF THE WHOLE OR PART OF THIS DOCUMENT CONSTITUTES AND INFRINGES COPYRIGHT. THE INFORMATION, IDEAS AND CONCEPTS CONTAINED IN THIS DOCUMENT IS / ARE CONFIDENTIAL. THE RECIPIENT(S) OF THIS DOCUMENT IS / ARE PROHIBITED FROM DISCLOSING SUCH INFORMATION IDEAS AND CONCEPTS TO ANY PERSON WITHOUT PRIOR WRITTEN CONSENT OF THE COPYRIGHT HOLDER. CONTRACTOR TO CHECK AND VERIFY ALL LEVELS, DATUMS, A DIMENSIONS ON SITE AND SHALL REPORT ANY DISCREPANCIES OR OMISSIONS TO THIS OFFICE PRIOR TO START OF WORK & DURING THE CONSTRUCTION PHASE. THIS DRAWING IS TO BE READ AND UNDERSTOOD IN CONJUNCTION WITH STRUCTURAL, MECHANICAL, ELECTRICAL AND/OR ANY OTHER CONSULTANTS DOCUMENTATION AS MAY BE APPLICABLE TO THE PROJECT PRIOR TO START OF WORK & ITS DURATION. MEASUREMENT SCALING OF THIS DRAWING SHALL ONLY BE PERMITTED IN ITS DIGITAL FORM.

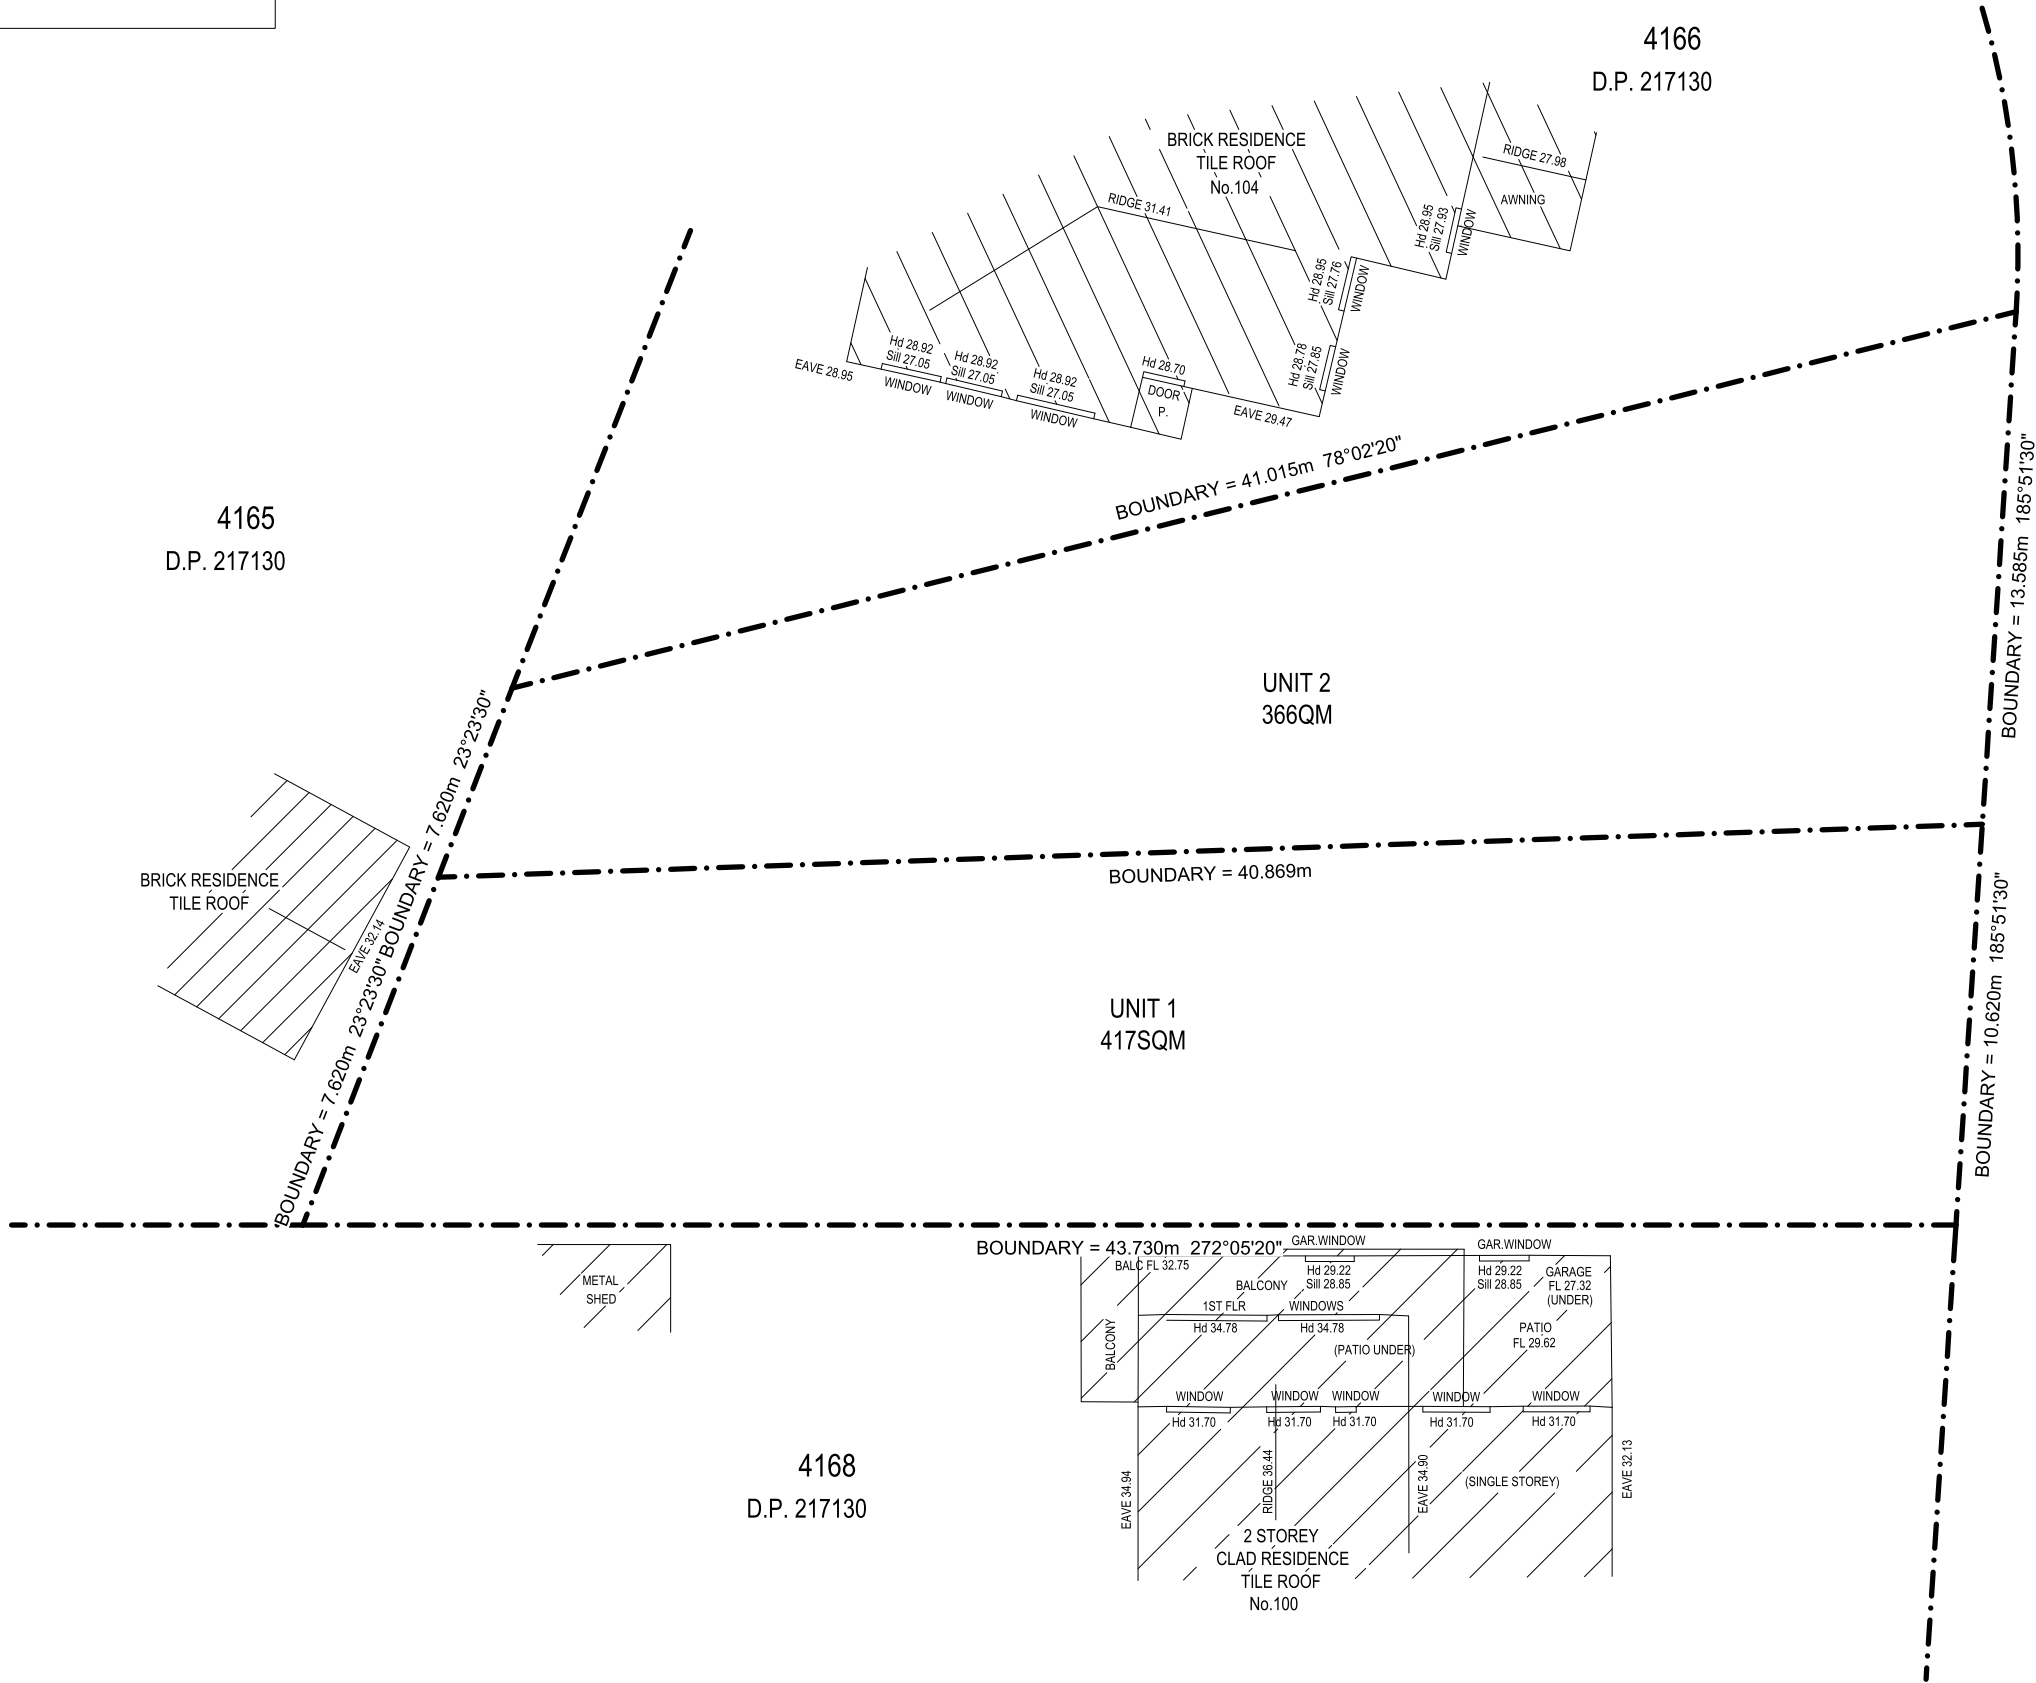

PROPOSED CONCEPT SUBDIVISION PLAN
SCALE - 1 : 200



03	AS PER COUNCIL REQUIREMENTS	SK	04.11.2024
02	AS PER COUNCIL REQUIREMENTS	SK	04.07.2024
01	DEVELOPMENT APPLICATION	SK	11.04.2023
REV	AMENDMENT DETAILS	BY	DATE

PROJECT STAGE
DEVELOPMENT APP.

PROJECT DETAILS
DETACHED DUAL-OCC

102 SANDAKAN ROAD,
REVESBY HEIGHTS

CLIENT DETAILS
LIVINGSTON HOMES

DRAWING TITLE
PROPOSED CONCEPT
SUBDIVISION PLAN

DRAWN
SK

DESIGNED
FB

CHECK
FB

DATE DRAWN
JULY 2024

DRAWING SCALE
1 : 200

SHEET SIZE
A3

0 1m 2m 3m 4m 5m 6m 7m 8m 9m 10m
X 1:100 @ A1 1:200 @ A3 1:267 @ A4



ACCREDITED
BUILDING DESIGNER

ACCREDITATION NUMBER: 6613 - MEMBER NUMBER 6763-21

PROJECT NUMBER FB0077	DRAWING NUMBER A.01.6	REVISION 03
--------------------------	--------------------------	----------------

CONSTRUCTION NOTES

- CONFIRM ALL DIMENSIONS ON SITE TO EXISTING RESIDENCE PRIOR TO COMMENCEMENT OF ANY WORK.
- SUPPLY AND INSTALL 'BIFLEX' CHEMICAL TERMITE TREATMENT (UNLESS OTHERWISE APPROVED) TO COMPLY WITH AS3660.1 AND MANUFACTURER'S SPECIFICATIONS
- ALL BRICKWORK (INCLUDING BRICK VENEER) SHALL BE IN ACCORDANCE WITH AS3700- MASONRY CODE
- ALL TIMBER FRAMING SHALL BE IN ACCORDANCE WITH AS1684. - UNLESS OTHERWISE APPROVED
- ROOF FRAMING SHALL BE OF TRADITIONAL TIMBER FRAMED CONSTRUCTION
- FOR ALL STRUCTURAL MEMBERS, FOOTINGS, & LOAD BEARING WALLS REFER TO STRUCTURAL DOCUMENTATION PREPARED BY ENGINEERS.

FEMME BUILD

NEW CONSTRUCTION
REMODELS
ADDITIONS
RENOVATIONS

0403 132 106
info@femmebuild.com.au

COPYRIGHT 2023 FEMME BUILD
REPRODUCTION OF THE WHOLE OR PART OF THIS DOCUMENT CONSTITUTES AND INFRINGES COPYRIGHT. THE INFORMATION, IDEAS AND CONCEPTS CONTAINED IN THIS DOCUMENT IS / ARE CONFIDENTIAL. THE RECIPIENT(S) OF THIS DOCUMENT IS / ARE PROHIBITED FROM DISCLOSING SUCH INFORMATION IDEAS AND CONCEPTS TO ANY PERSON WITHOUT PRIOR WRITTEN CONSENT OF THE COPYRIGHT HOLDER. CONTRACTOR TO CHECK AND VERIFY ALL LEVELS, DATUMS, A DIMENSIONS ON SITE AND SHALL REPORT ANY DISCREPANCIES OR OMISSIONS TO THE OFFICE PRIOR TO START OF WORK & DURING THE CONSTRUCTION PHASE. THIS DRAWING IS TO BE READ AND UNDERSTOOD IN CONJUNCTION WITH STRUCTURAL, MECHANICAL, ELECTRICAL AND OR ANY OTHER CONSULTANTS DOCUMENTATION AS MAY BE APPLICABLE TO THE PROJECT PRIOR TO START OF WORK & ITS DURATION. MEASUREMENT SCALING OF THIS DRAWING SHALL ONLY BE PERMITTED IN ITS DIGITAL FORM.

WALL SCHEDULE

WALL SARKING & BULK INSULATION AS
REQUIRED BY ENERGY ASSESSMENT

- BRICK VENEER WALL.**
SELECTED. EXPOSED FACE BRICK (RE-USE RECYCLED BRICK FROM DEMOLITION).
INTERIOR FINISH OTHER - PROVIDE FLUSH PLASTER FINISH.
- EXTERIOR & INTERIOR TIMBER STUD WALL.**
SELECTED. HORIZONTAL WEATHERBOARDS FIXED TO TIMBER STUD.
INTERIOR FINISH TO BE FLUSH PLASTERBOARD UNLESS SPECIFIED OTHERWISE.



03	AS PER COUNCIL REQUIREMENTS	SK	04.11.2024
02	AS PER COUNCIL REQUIREMENTS	SK	04.07.2024
01	DEVELOPMENT APPLICATION	SK	11.04.2023
REV	AMENDMENT DETAILS	BY	DATE

PROJECT STAGE
DEVELOPMENT APP.

PROJECT DETAILS
DETACHED DUAL-OCC

102 SANDAKAN ROAD,
REVESBY HEIGHTS

CLIENT DETAILS
LIVINGSTON HOMES

DRAWING TITLE
PROPOSED
GROUND FLOOR PLAN

DRAWN

SK

DESIGNED

FB

CHECK

FB

DATE DRAWN
JULY 2024

DRAWING SCALE
1 : 100

SHEET SIZE
A1

0 1m 2m 3m 4m 5m 6m 7m 8m 9m 10m
1:100 @ A1 1:200 @ A3 1:267 @ A4




ACCREDITED
BUILDING DESIGNER

ACCREDITATION NUMBER: 6613 - MEMBER NUMBER 6763-21

PROJECT NUMBER
FB0077

DRAWING NUMBER
A.02.1

REVISION
03

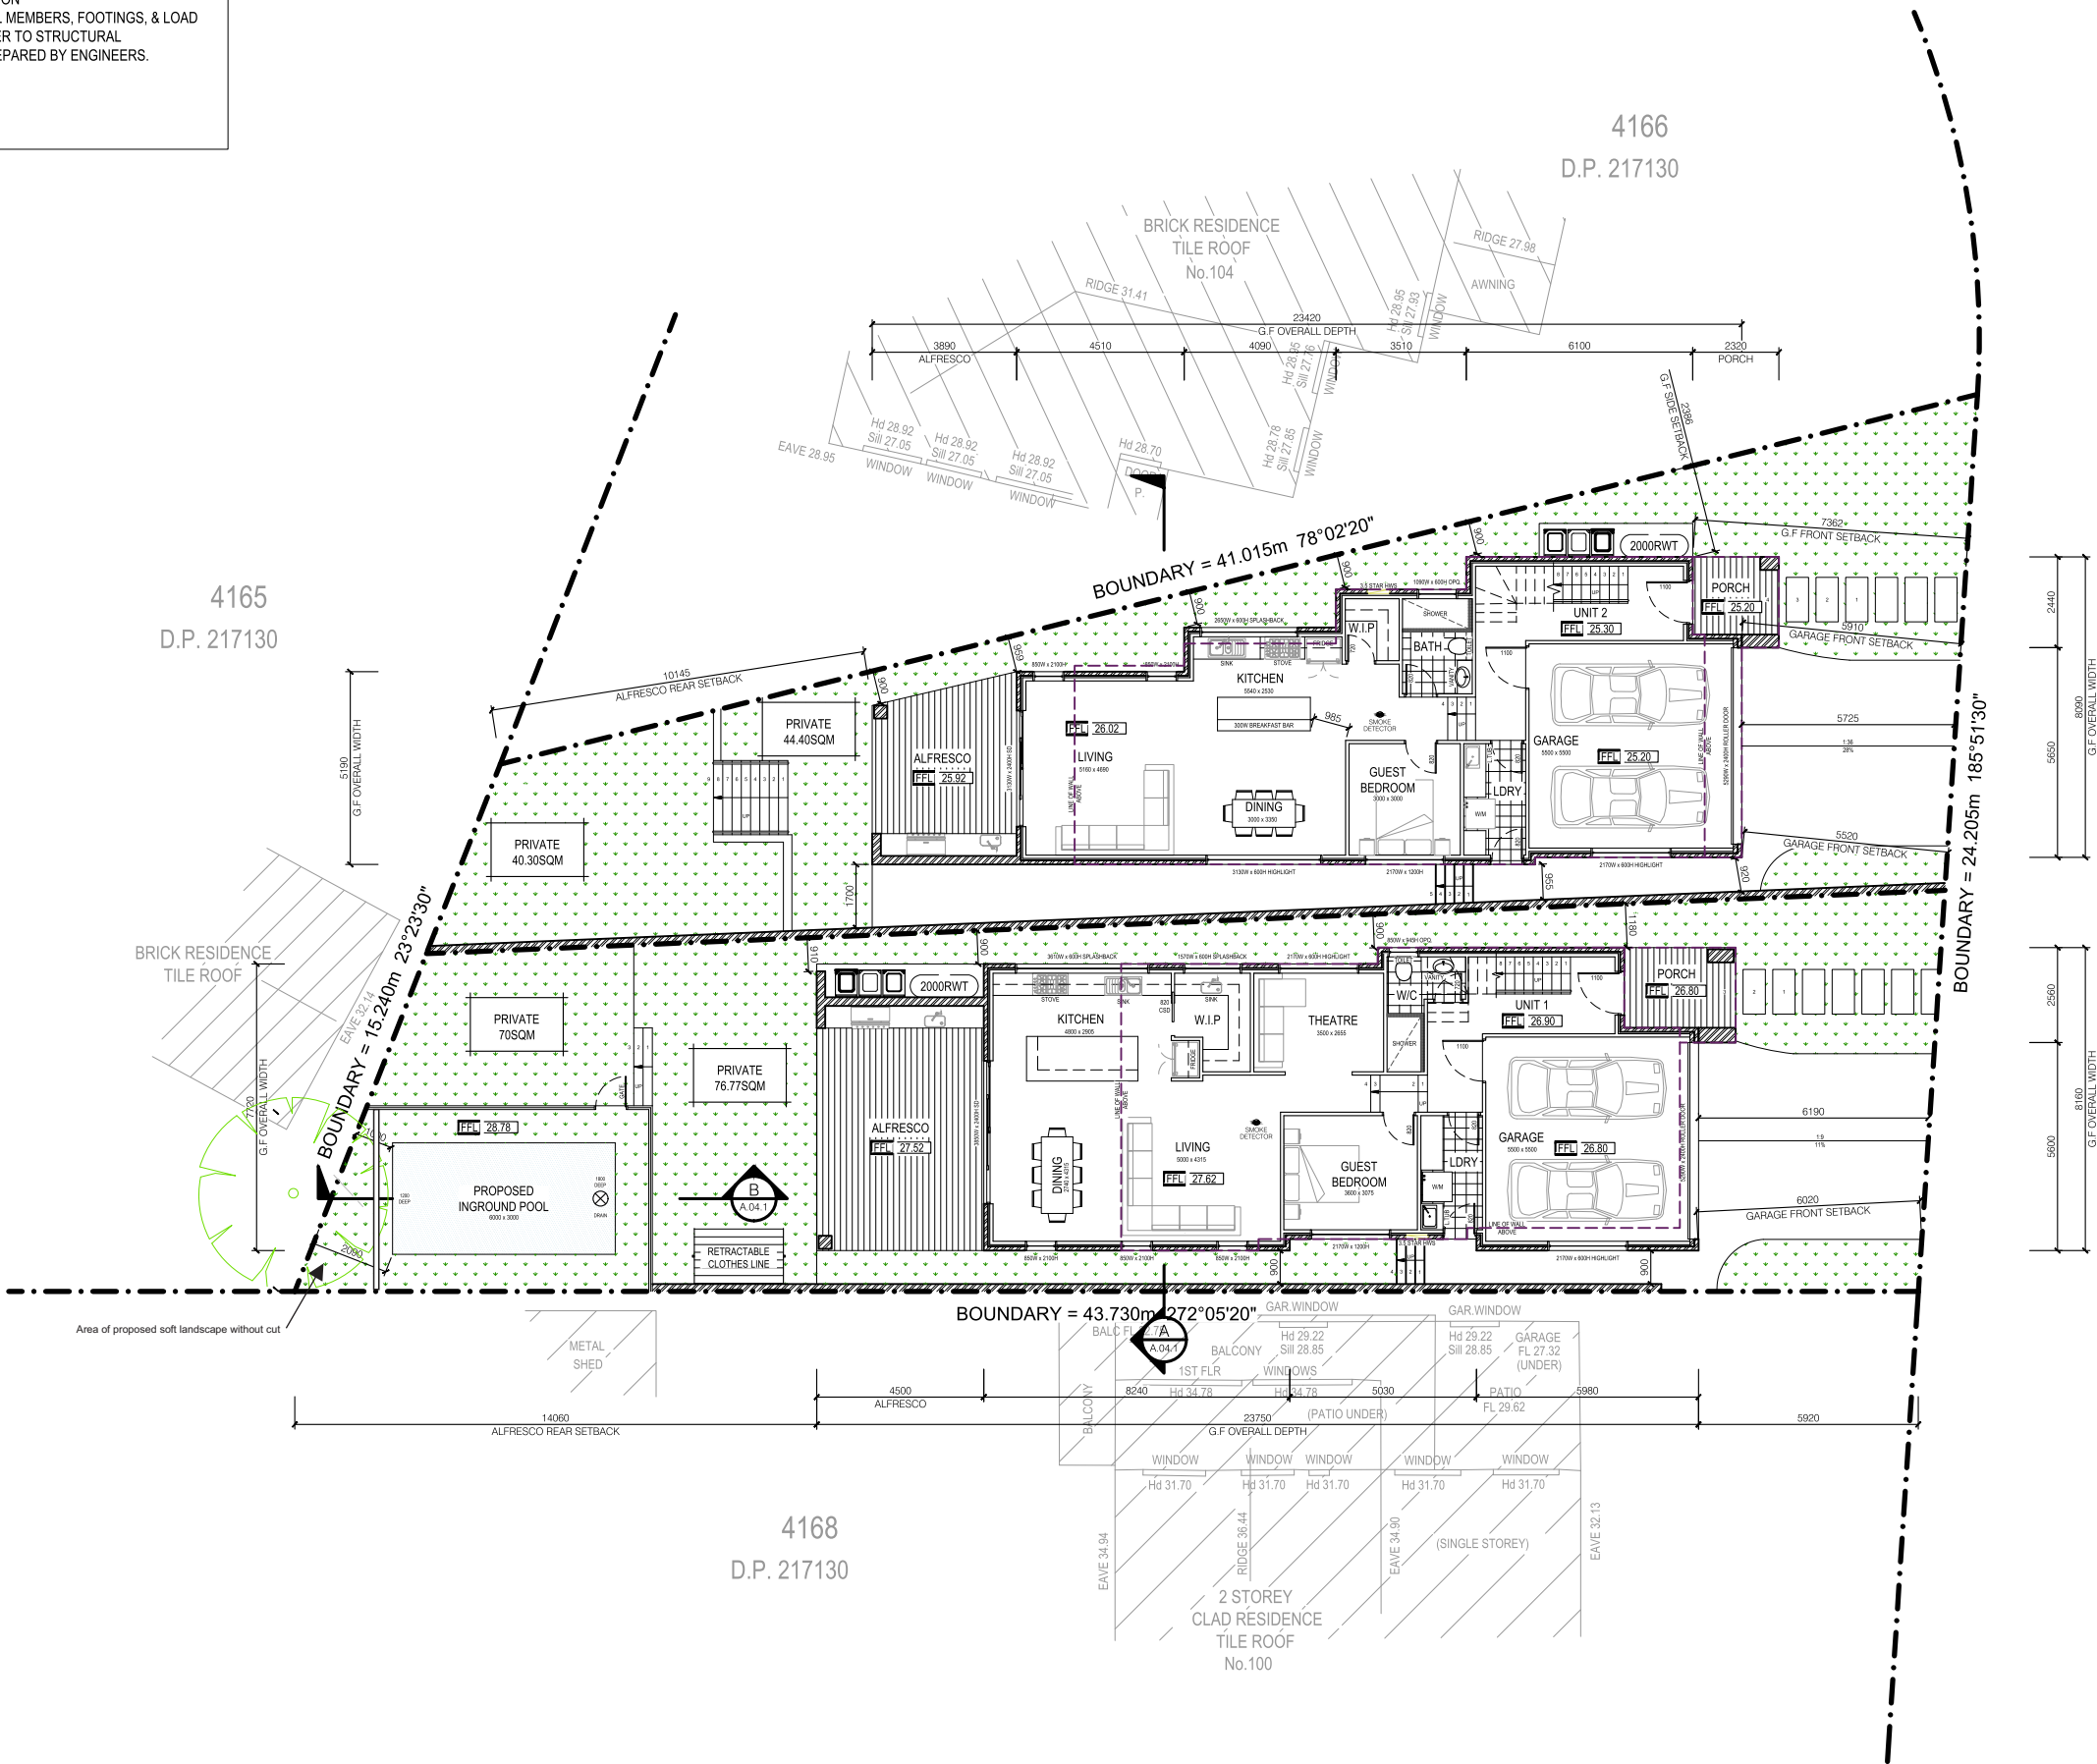

PROPOSED GROUND FLOOR PLAN
SCALE - 1 : 100



ELEVATION DIRECTION

CONSTRUCTION NOTES

- CONFIRM ALL DIMENSIONS ON SITE TO EXISTING RESIDENCE PRIOR TO COMMENCEMENT OF ANY WORK.
- SUPPLY AND INSTALL 'BIFLEX' CHEMICAL TERMITE TREATMENT (UNLESS OTHERWISE APPROVED) TO COMPLY WITH AS3660.1 AND MANUFACTURER'S SPECIFICATIONS
- ALL BRICKWORK (INCLUDING BRICK VENEER) SHALL BE IN ACCORDANCE WITH AS3700- MASONRY CODE
- ALL TIMBER FRAMING SHALL BE IN ACCORDANCE WITH AS1684. - UNLESS OTHERWISE APPROVED ROOF FRAMING SHALL BE OF TRADITIONAL TIMBER FRAMED CONSTRUCTION
- FOR ALL STRUCTURAL MEMBERS, FOOTINGS, & LOAD BEARING WALLS REFER TO STRUCTURAL DOCUMENTATION PREPARED BY ENGINEERS.

FEMME BUILD

NEW CONSTRUCTION
REMODELS
ADDITIONS
RENOVATIONS

0403 132 106
info@femmebuild.com.au

COPYRIGHT 2023 FEMME BUILD
REPRODUCTION OF THE WHOLE OR PART OF THIS DOCUMENT CONSTITUTES AND INFRINGES COPYRIGHT. THE INFORMATION, IDEAS AND CONCEPTS CONTAINED IN THIS DOCUMENT IS / ARE CONFIDENTIAL. THE RECIPIENTS OF THIS DOCUMENT IS / ARE PROHIBITED FROM DISCLOSING SUCH INFORMATION IDEAS AND CONCEPTS TO ANY PERSON WITHOUT PRIOR WRITTEN CONSENT OF THE COPYRIGHT HOLDER. CONTRACTOR TO CHECK AND VERIFY ALL LEVELS, DATUMS & DIMENSIONS ON SITE AND SHALL REPORT ANY DISCREPANCIES OR OMISSIONS TO THIS OFFICE PRIOR TO START OF WORK & DURING THE CONSTRUCTION PHASE. THIS DRAWING IS TO BE READ AND UNDERSTOOD IN CONJUNCTION WITH STRUCTURAL, MECHANICAL, ELECTRICAL AND OR ANY OTHER CONSULTANTS DOCUMENTATION AS MAY BE APPLICABLE TO THE PROJECT PRIOR TO START OF WORK & ITS DURATION. MEASUREMENT SCALING OF THIS DRAWING SHALL ONLY BE PERMITTED IN ITS DIGITAL FORM.

WALL SCHEDULE

WALL SARKING & BULK INSULATION AS
REQUIRED BY ENERGY ASSESSMENT

- BRICK VENEER WALL.**
SELECTED. EXPOSED FACE BRICK (RE-USE RECYCLED BRICK FROM DEMOLITION).
INTERIOR FINISH OTHER - PROVIDE FLUSH PLASTER FINISH.
- EXTERIOR & INTERIOR TIMBER STUD WALL.**
SELECTED. HORIZONTAL WEATHERBOARDS FIXED TO TIMBER STUD.
INTERIOR FINISH TO BE FLUSH PLASTERBOARD UNLESS SPECIFIED OTHERWISE.



03	AS PER COUNCIL REQUIREMENTS	SK	04.11.2024
02	AS PER COUNCIL REQUIREMENTS	SK	04.07.2024
01	DEVELOPMENT APPLICATION	SK	11.04.2023
REV	AMENDMENT DETAILS	BY	DATE

PROJECT STAGE
DEVELOPMENT APP.

PROJECT DETAILS
DETACHED DUAL-OCC

102 SANDAKAN ROAD,
REVESBY HEIGHTS

CLIENT DETAILS
LIVINGSTON HOMES

DRAWING TITLE
PROPOSED
FIRST FLOOR PLAN

DRAWN

SK

DESIGNED

FB

CHECK

FB

DATE DRAWN
JULY 2024

DRAWING SCALE
1 : 100

SHEET SIZE
A1

0 1m 2m 3m 4m 5m 6m 7m 8m 9m 10m
1:100 @ A1 1:200 @ A3 1:267 @ A4




ACCREDITED
BUILDING DESIGNER

ACCREDITATION NUMBER: 6613 - MEMBER NUMBER 6763-21

PROJECT NUMBER
FB0077

DRAWING NUMBER
A.02.2

REVISION
03

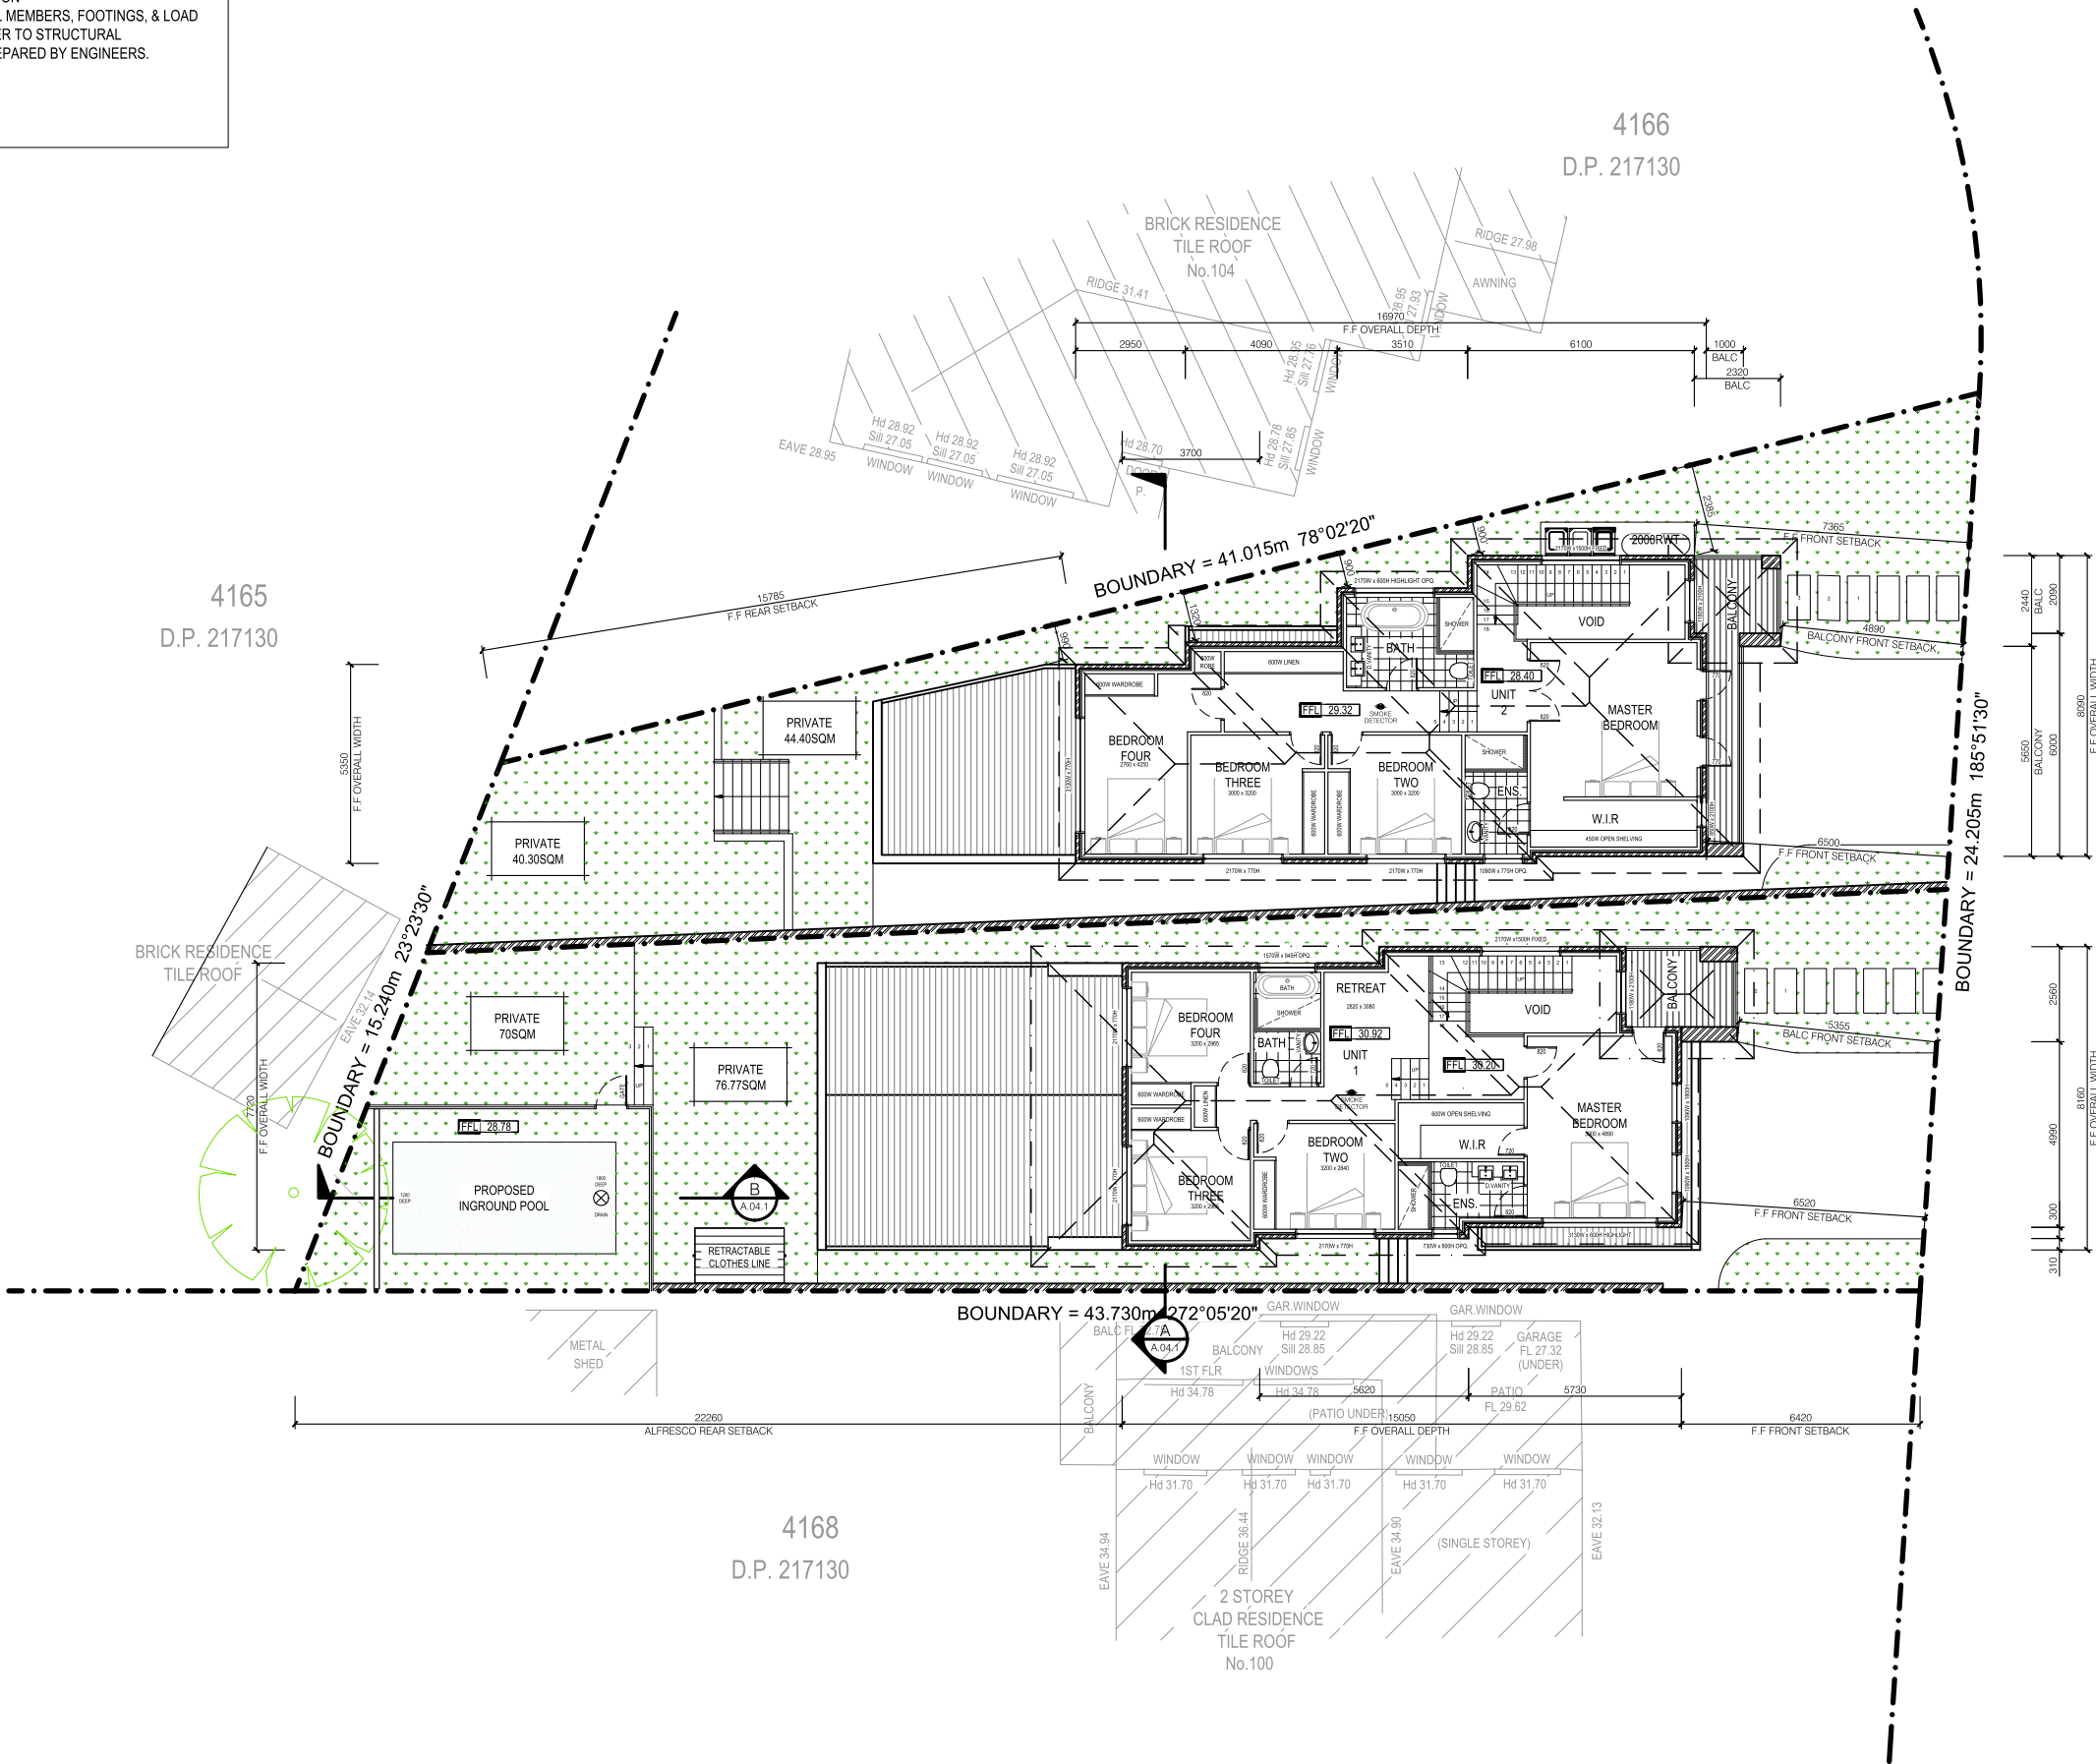

PROPOSED FIRST FLOOR PLAN
SCALE - 1 : 100




ELEVATION DIRECTION

CONSTRUCTION NOTES

- CONFIRM ALL DIMENSIONS ON SITE TO EXISTING RESIDENCE PRIOR TO COMMENCEMENT OF ANY WORK.
- SUPPLY AND INSTALL 'BIFLEX' CHEMICAL TERMITE TREATMENT (UNLESS OTHERWISE APPROVED) TO COMPLY WITH AS3660.1 AND MANUFACTURER'S SPECIFICATIONS
- ALL BRICKWORK (INCLUDING BRICK VENEER) SHALL BE IN ACCORDANCE WITH AS3700- MASONRY CODE
- ALL TIMBER FRAMING SHALL BE IN ACCORDANCE WITH AS1684. - UNLESS OTHERWISE APPROVED
- ROOF FRAMING SHALL BE OF TRADITIONAL TIMBER FRAMED CONSTRUCTION
- FOR ALL STRUCTURAL MEMBERS, FOOTINGS, & LOAD BEARING WALLS REFER TO STRUCTURAL DOCUMENTATION PREPARED BY ENGINEERS.

FEMME BUILD
NEW CONSTRUCTION
REMODELS
ADDITIONS
RENOVATIONS
0403 132 106
info@femmebuild.com.au

COPYRIGHT 2023 FEMME BUILD
REPRODUCTION OF THE WHOLE OR PART OF THIS DOCUMENT CONSTITUTES AND INFRINGES COPYRIGHT. THE INFORMATION, IDEAS AND CONCEPTS CONTAINED IN THIS DOCUMENT IS / ARE CONFIDENTIAL. THE RECIPIENT(S) OF THIS DOCUMENT IS / ARE PROHIBITED FROM DISCLOSING SUCH INFORMATION IDEAS AND CONCEPTS TO ANY PERSON WITHOUT PRIOR WRITTEN CONSENT OF THE COPYRIGHT HOLDER. CONTRACTOR TO CHECK AND VERIFY ALL LEVELS, DATUMS, A DIMENSIONS ON SITE AND SHALL REPORT ANY DISCREPANCIES OR OMISSIONS TO THIS OFFICE PRIOR TO START OF WORK & DURING THE CONSTRUCTION PHASE. THIS DRAWING IS TO BE READ AND UNDERSTOOD IN CONJUNCTION WITH STRUCTURAL, MECHANICAL, ELECTRICAL AND OR ANY OTHER CONSULTANTS DOCUMENTATION AS MAY BE APPLICABLE TO THE PROJECT PRIOR TO START OF WORK & ITS DURATION. MEASUREMENT SCALING OF THIS DRAWING SHALL ONLY BE PERMITTED IN ITS DIGITAL FORM.

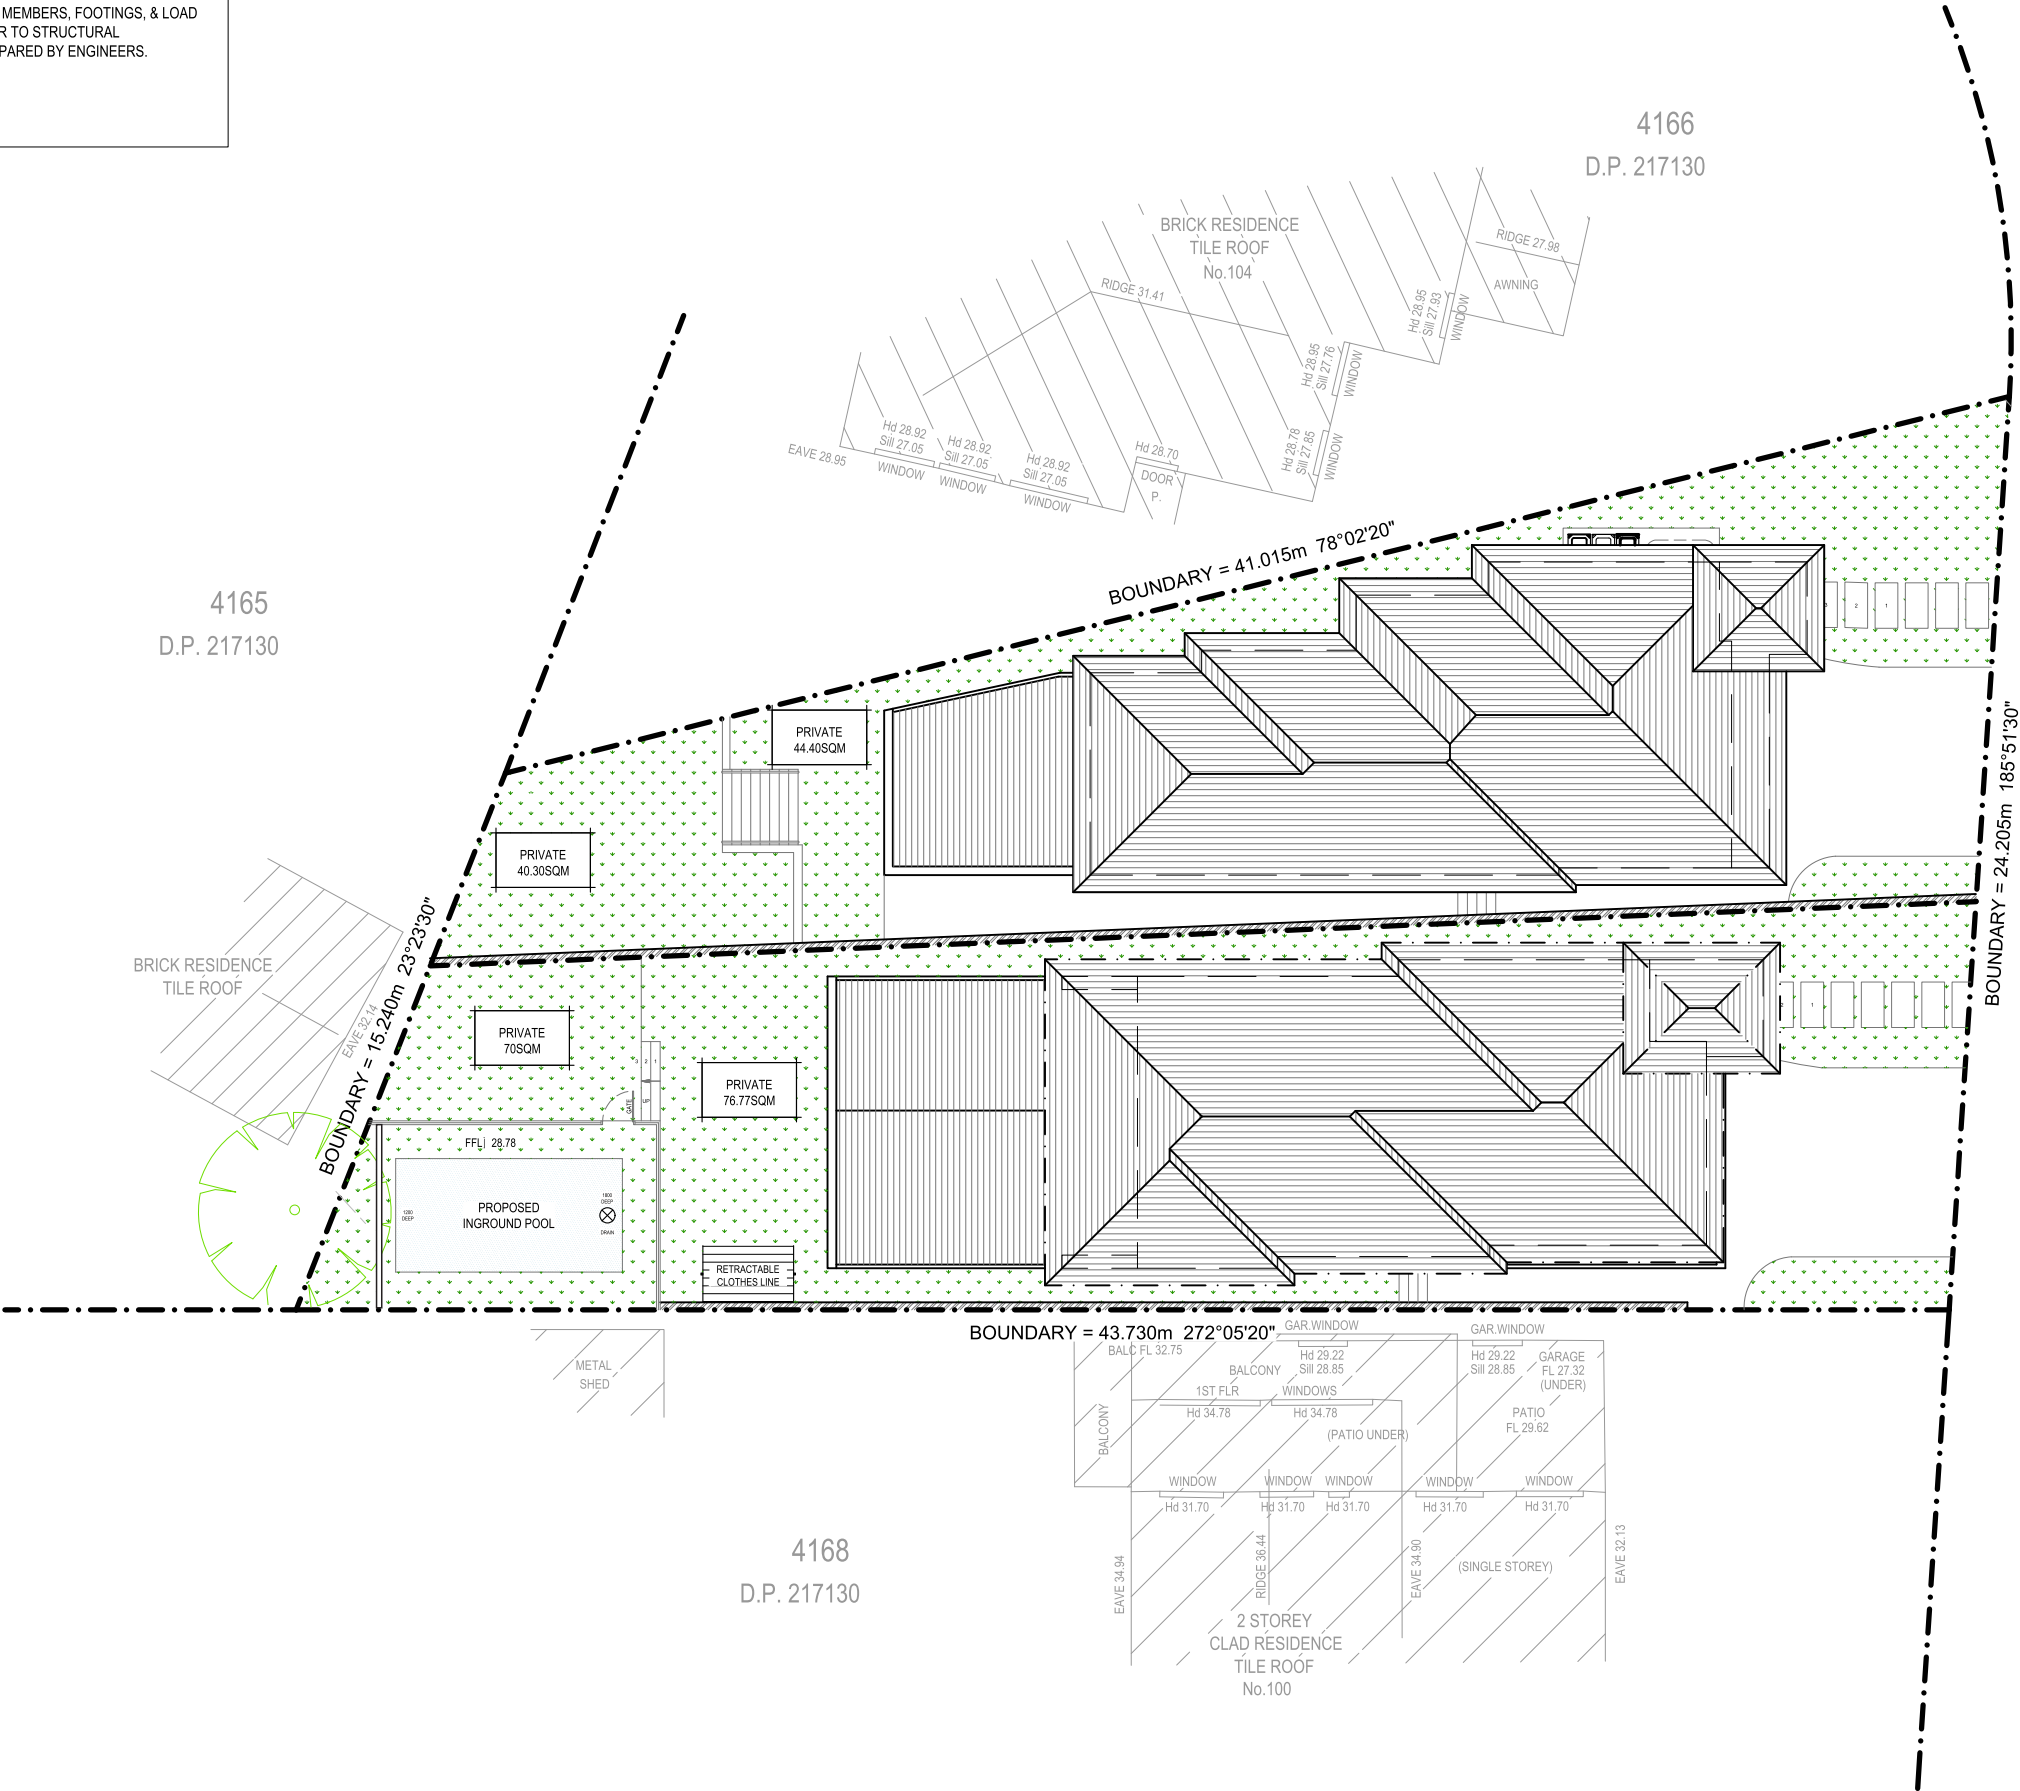

PROPOSED ROOF PLAN
SCALE - 1 : 200



03	AS PER COUNCIL REQUIREMENTS	SK	04.11.2024
02	AS PER COUNCIL REQUIREMENTS	SK	04.07.2024
01	DEVELOPMENT APPLICATION	SK	11.04.2023
REV	AMENDMENT DETAILS	BY	DATE

PROJECT STAGE
DEVELOPMENT APP.

PROJECT DETAILS
DETACHED DUAL-OCC
102 SANDAKAN ROAD,
REVESBY HEIGHTS

CLIENT DETAILS
LIVINGSTON HOMES

DRAWING TITLE
PROPOSED
ROOF PLAN



DRAWN
SK
DESIGNED
FB
CHECK
FB
DATE DRAWN
JULY 2024
DRAWING SCALE
1 : 200
SHEET SIZE
A3

0 1m 2m 3m 4m 5m 6m 7m 8m 9m 10m
X 1:100 @ A1 1:200 @ A3 1:267 @ A4

bdaa
ACCREDITED
BUILDING DESIGNER

ACCREDITATION NUMBER: 6613 - MEMBER NUMBER 6763-21

PROJECT NUMBER FB0077	DRAWING NUMBER A.02.3	REVISION 03
--------------------------	--------------------------	----------------

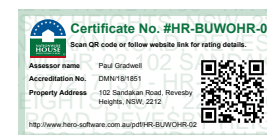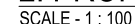


FEMME BUILD

NEW CONSTRUCTION
REMODELS
ADDITIONS
RENOVATIONS

0403 132 106


info@femmebuild.com.au

COPYRIGHT 2023 FEMME BUILD
REPRODUCTION OF THE WHOLE OR PART OF THIS DOCUMENT CONSTITUTES AND INFRINGES COPYRIGHT. THE INFORMATION, IDEAS AND CONCEPTS CONTAINED IN THIS DOCUMENT IS/ARE CONFIDENTIAL. THE RECIPIENT(S) OF THIS DOCUMENT IS/ARE PROHIBITED FROM DISCLOSING SUCH INFORMATION IDEAS AND CONCEPTS TO ANY PERSON WITHOUT PRIOR WRITTEN CONSENT OF THE COPYRIGHT HOLDER. CONTRACTOR TO CHECK AND VERIFY ALL LEVELS, DATUMS, A DIMENSIONS ON SITE AND SHALL REPORT ANY DISCREPANCIES OR OMISSIONS TO THIS OFFICE PRIOR TO START OF WORK & DURING THE CONSTRUCTION PHASE. THIS DRAWING IS TO BE USED AND UNDERSTOOD IN CONJUNCTION WITH STRUCTURAL, MECHANICAL, ELECTRICAL AND/OR ANY OTHER RELEVANT DOCUMENTATION AS MAY BE APPLICABLE TO THE PROJECT PRIOR TO START OF WORK & ITS DURATION. MEASUREMENT SCALING OF THIS DRAWING SHALL ONLY BE PERMITTED IN ITS DIGITAL FORM.

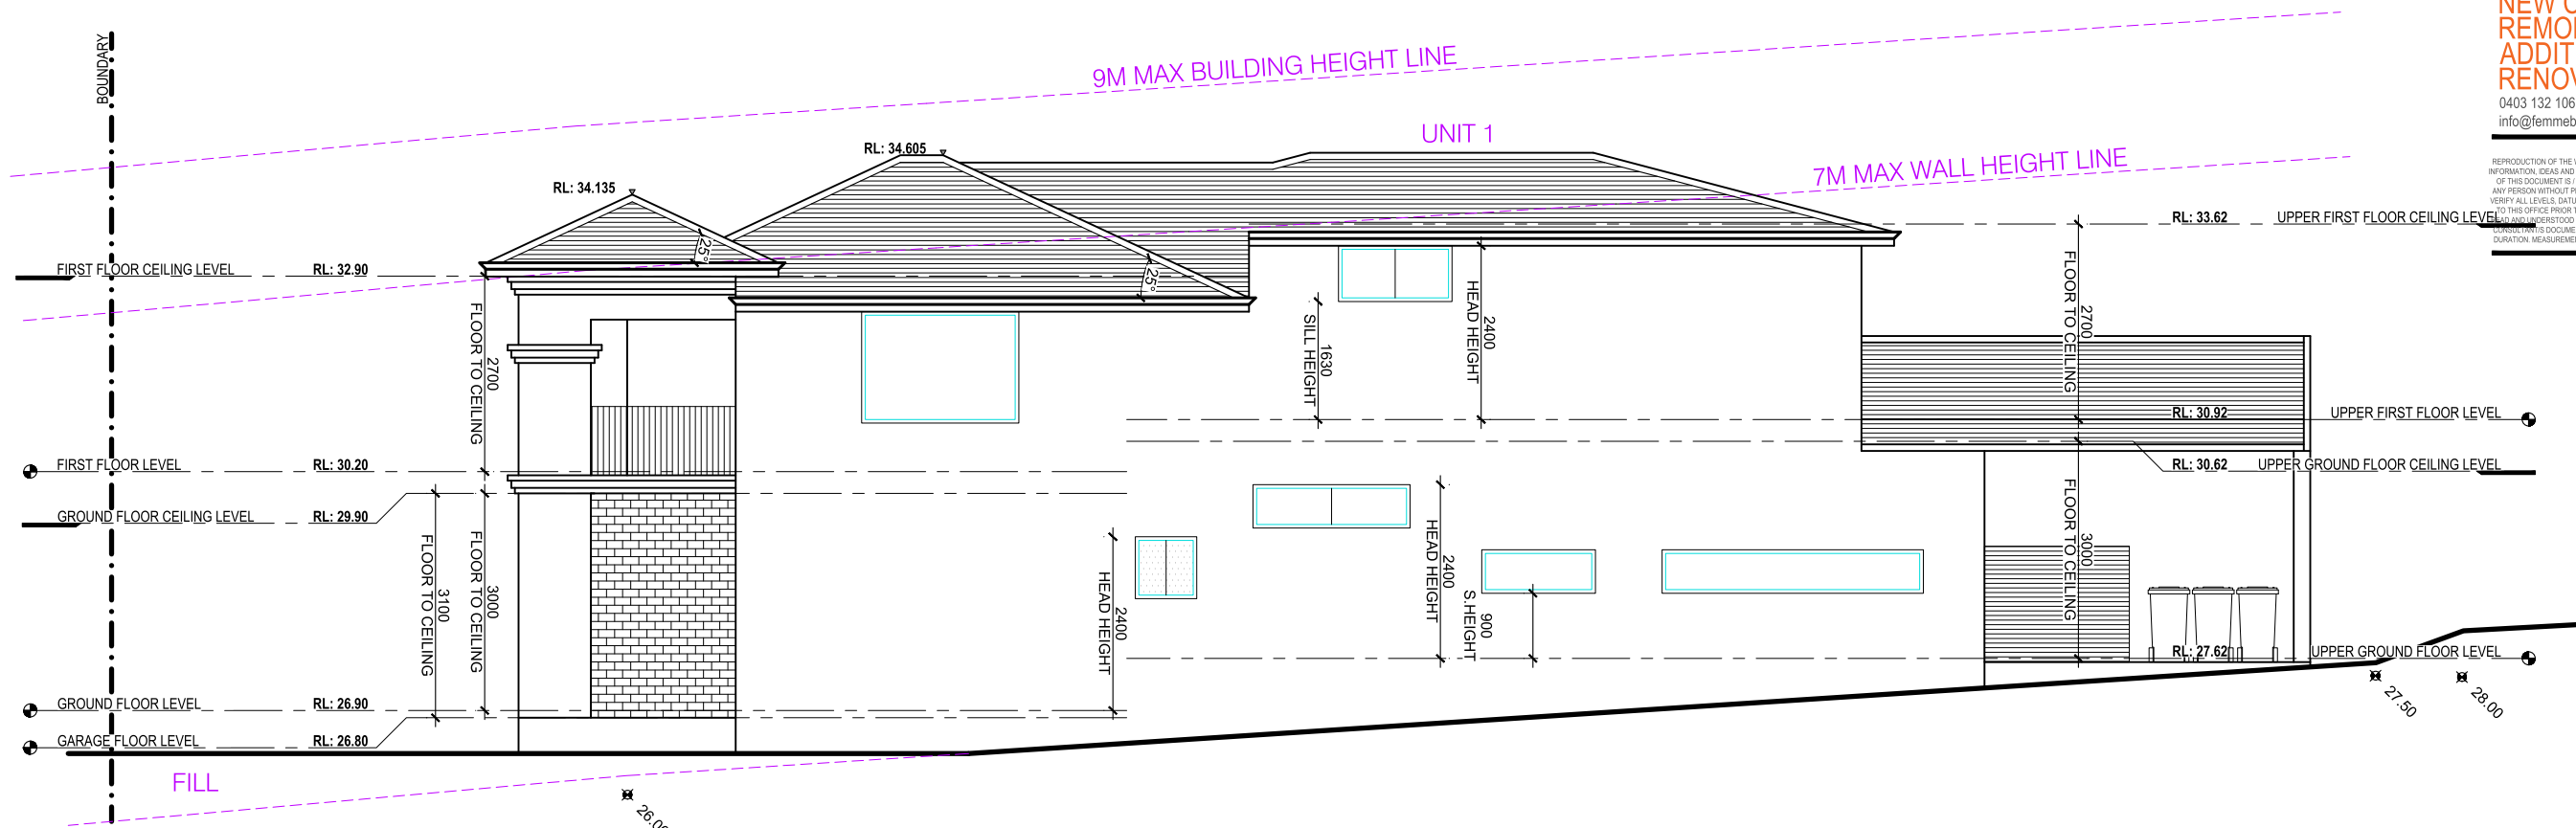

3. PROPOSED NORTHERN ELEVATION

SCALE - 1 : 100

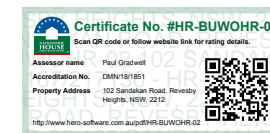

03	AS PER COUNCIL REQUIREMENTS	SK	04.11.2024
02	AS PER COUNCIL REQUIREMENTS	SK	04.07.2024
01	DEVELOPMENT APPLICATION	SK	11.04.2023
REV	AMENDMENT DETAILS	BY	DATE

DEVELOPMENT APP.

DETACHED DUAL-OCC

102 SANDAKAN ROAD,
REVESBY HEIGHTS

CLIENT DETAILS
LIVINGSTON HOMES

PROPOSED ELEVATIONS 3 & 4

DRAWN

SK

DESIGNED

FB


CHECK

FB

DATE DRAWN
JULY 2024

DRAWING SCALE
1 : 100


SHEET SIZE
A3

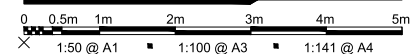

ACCREDITED
BUILDING DESIGNER

ACCREDITATION NUMBER: 6613 - MEMBER NUMBER 6763-21

PROJECT NUMBER FB0077	DRAWING NUMBER A.03.2	REVISION 03
--------------------------	--------------------------	----------------

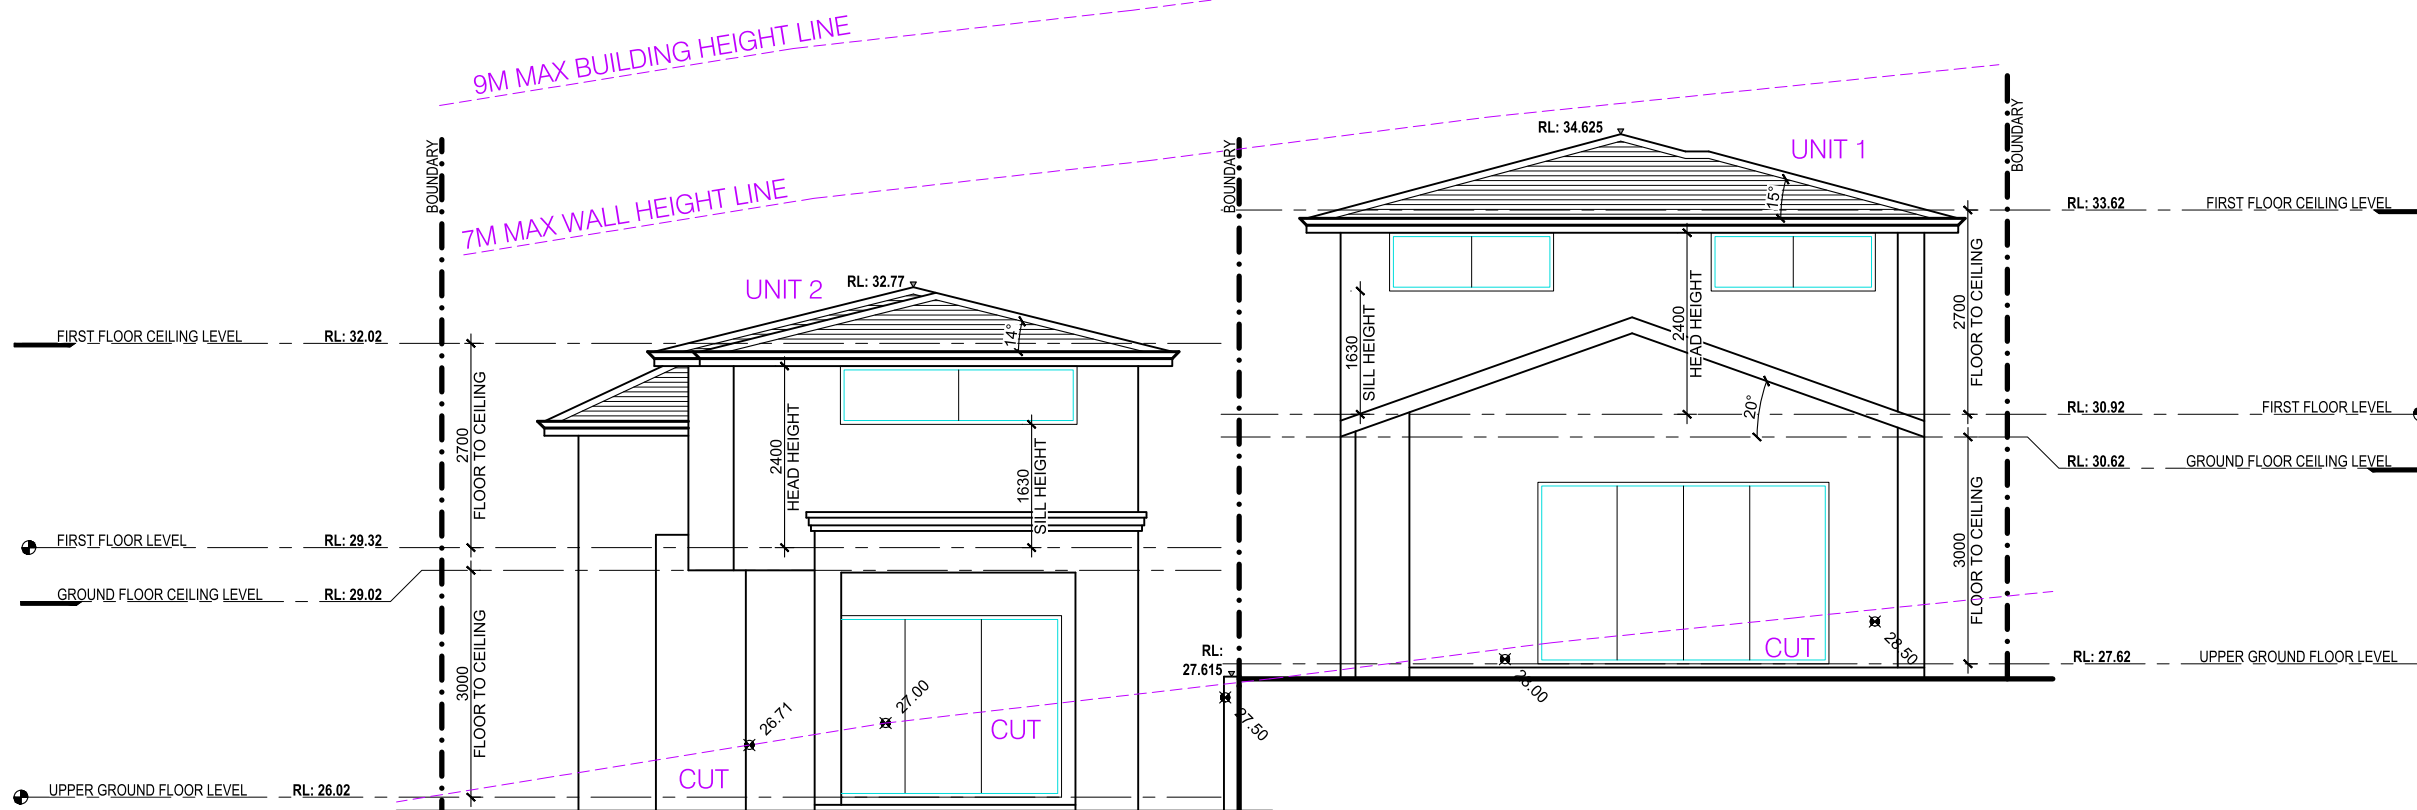



4. PROPOSED WESTERN ELEVATION

SCALE - 1 : 100




ACCREDITATION NUMBER: 6613 - MEMBER NUMBER 6763-21

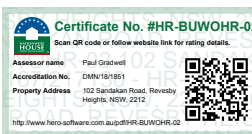

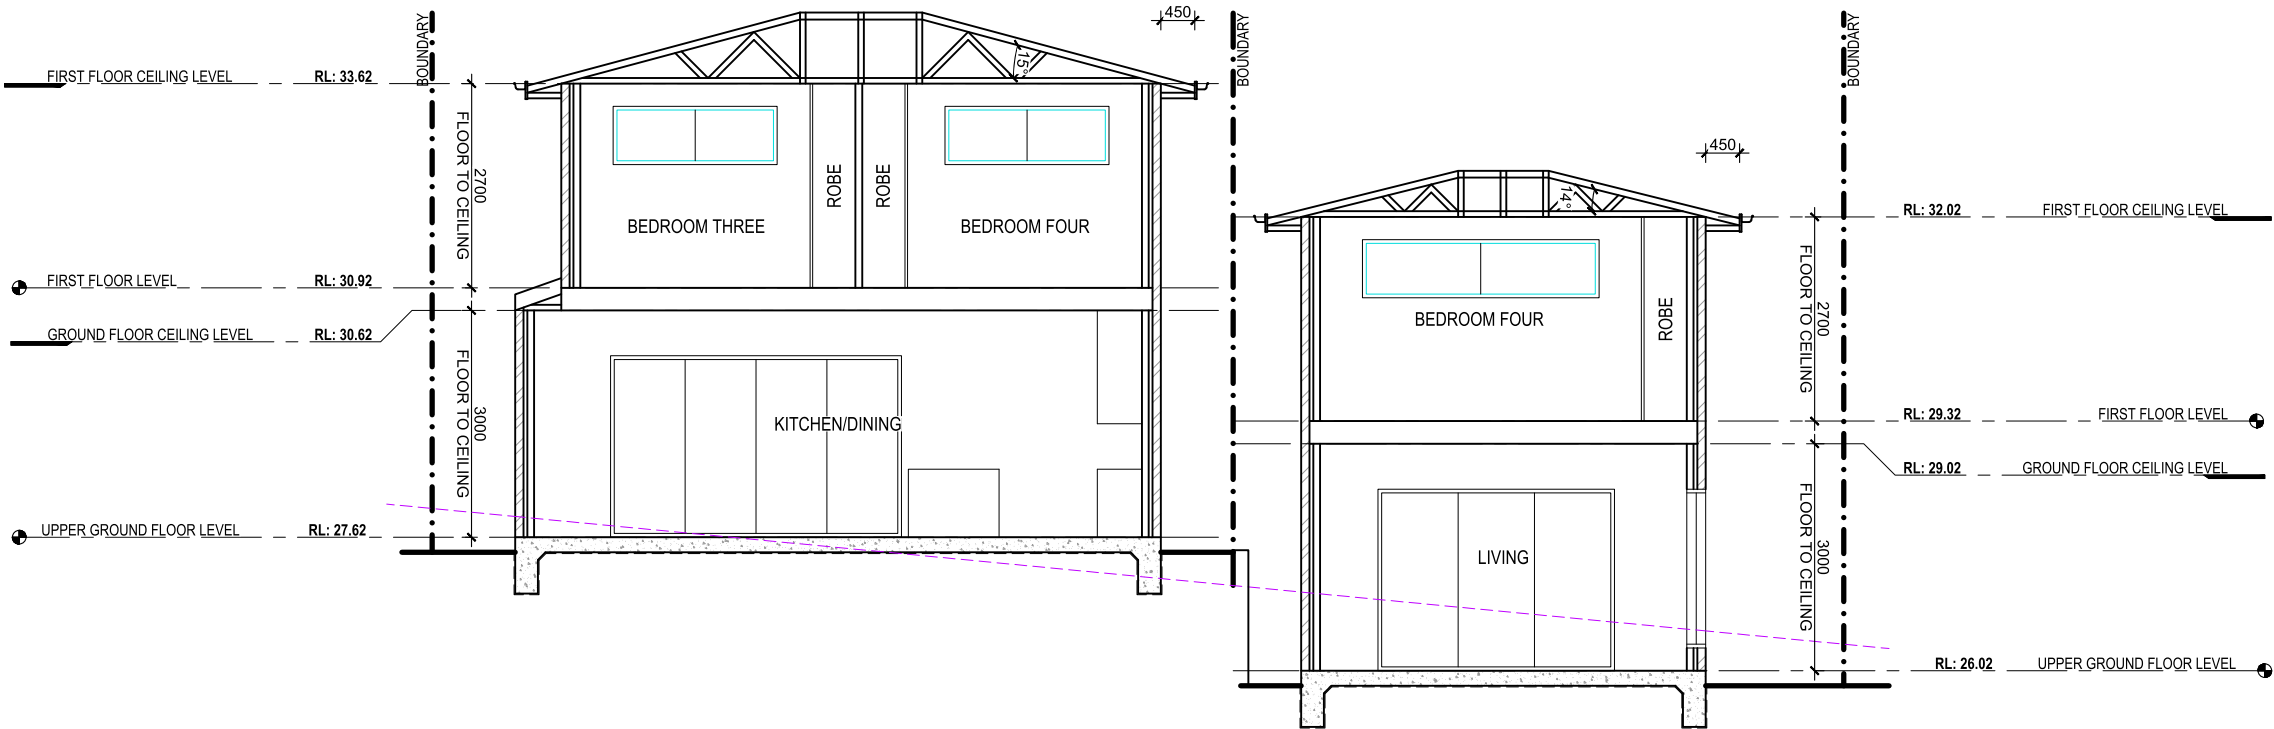

SECTION A
SCALE - 1 : 100

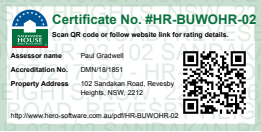

03	AS PER COUNCIL REQUIREMENTS	SK	04.11.2024
02	AS PER COUNCIL REQUIREMENTS	SK	04.07.2024
01	DEVELOPMENT APPLICATION	SK	11.04.2023
REV	AMENDMENT DETAILS	BY	DATE

PROJECT STAGE
DEVELOPMENT APP.

PROJECT DETAILS
DETACHED DUAL-OCC
102 SANDAKAN ROAD,
REVESBY HEIGHTS

CLIENT DETAILS
LIVINGSTON HOMES

DRAWING TITLE
**PROPOSED
SECTION & DETAILS**

DRAWN
SK
DESIGNED
FB
CHECK
FB

DATE DRAWN
JULY 2024
DRAWING SCALE
AS SHOWN
SHEET SIZE
A3
0 0.5m 1m 2m 3m 4m 5m
1:50 @ A1 1:100 @ A3 1:141 @ A4

bdad
**ACCREDITED
BUILDING DESIGNER**

ACCREDITATION NUMBER: 6613 - MEMBER NUMBER 6763-21

PROJECT NUMBER
FB0077
DRAWING NUMBER
A.04.1
REVISION
03

Project: Address: 102 Sandakan Road Revesby Heights NSW 2212 File Ref: HEC2770

Applicant: Name: TBC Designer: FEMME BUILD

Assessor: Name: Paul Gradwell Company: House Energy Certified
Address: PO BOX 3136 Tamarama NSW 2026 Number: DMN/18/4423
Contact: 02 9130 2068 Email: paul@houseenergycertified.com

Ext. Walls:	Construction	Insulation	Colour	Details
	Brick Veneer	None	Varies	To garage
	Brick Veneer	R2.7 added	Varies	As per plans

Int. Walls:	Construction	Insulation	Details
	Plasterboard on Stud	R2.7 added	To garage

Floors:	Construction	Insulation	Details
	Concrete	R1.0 added	Slab edge insulation
	Timber	R4.0 added	Above garage

Ceilings:	Construction	Insulation	Details
	Plasterboard	R5.0 added	As per plans


Roof:	Construction	Insulation	Colour	Details
	Tiles	Sarking	Dark	As per plans
	Metal Deck	60mm Anticon (R1.3)	Dark	As per plans

Windows:	Product ID	Glass	Frame	Uw/SHGCw	Details
Group B	ALM-006-03 A	Double Clear	Aluminium	4.1/0.52	Sliding, Sliding Door, Fixed (Unit1)
Group A	BRD-026-19 A	Single Low E	Aluminium	4.9/0.52	Hinged Door (Unit 2)
Group B	ALM-004-03 A	Double Clear	Aluminium	4.3/0.53	Sliding, Sliding Door, Fixed at Kitchen/Living (Unit2)
Group B	ALS-009-21 A	Single Low E	Aluminium	4.9/0.53	Sliding, Sliding Door, Fixed elsewhere (Unit2)

Skylights:	Product ID	Glass	Type	Uw/SHGCw	Details
------------	------------	-------	------	----------	---------


Other:	Orientation	Terrain	Rangehood	Recessed Downlights	Software Version
	330	Suburban	Ducted	Sealed LED - 1 per 2.5m ²	HERO

Notes
1 x 1500mm ceiling fan to living
1 x 1200mm ceiling fan to bedrooms

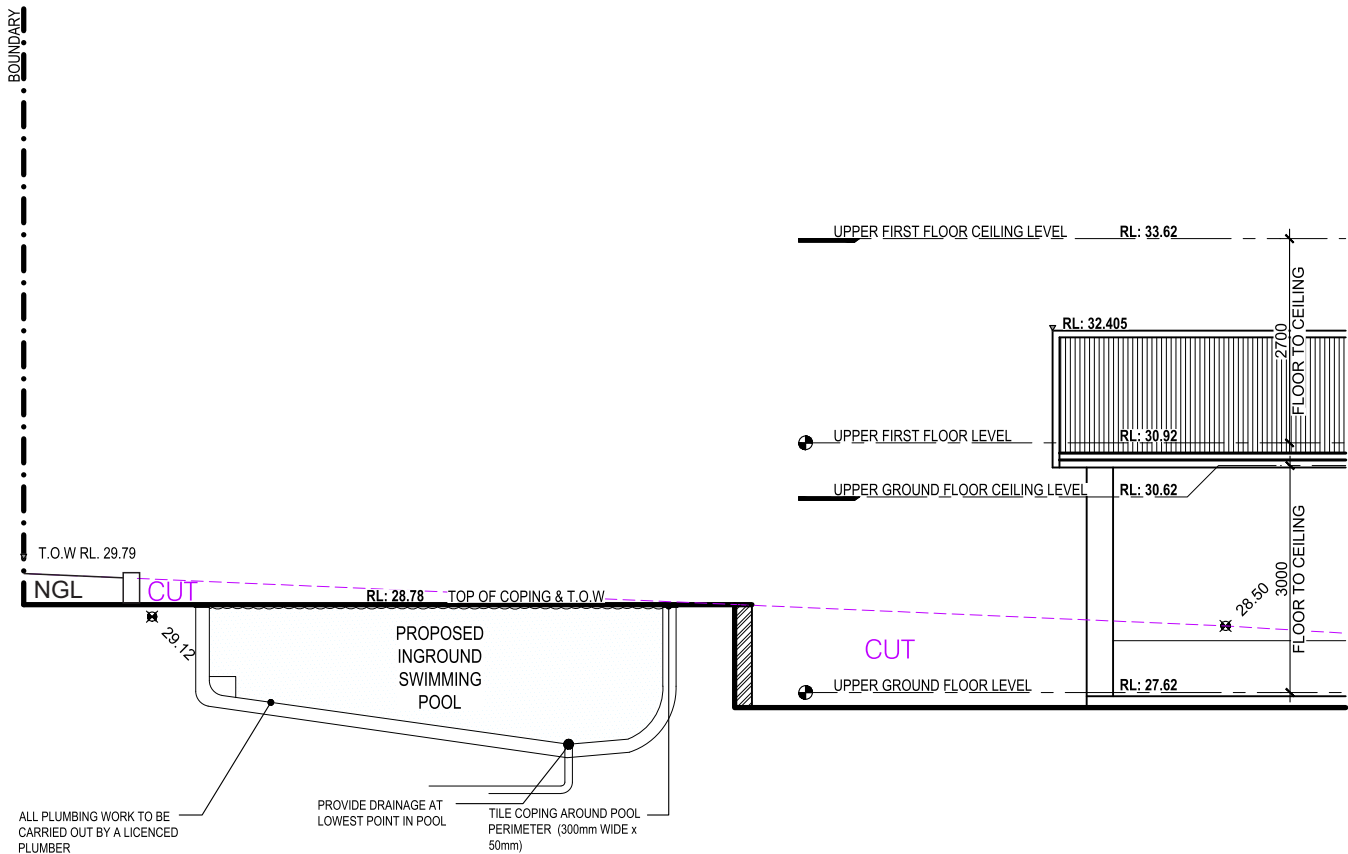

SECTION B
SCALE - 1 : 100

COPYRIGHT 2023 FEMME BUILD
REPRODUCTION OF THE WHOLE OR PART OF THIS DOCUMENT CONSTITUTES AND INFRINGES COPYRIGHT. THE INFORMATION, IDEAS AND CONCEPTS CONTAINED IN THIS DOCUMENT IS / ARE CONFIDENTIAL. THE RECIPIENT(S) OF THIS DOCUMENT IS / ARE PROHIBITED FROM DISCLOSING SUCH INFORMATION IDEAS AND CONCEPTS TO ANY PERSON WITHOUT PRIOR WRITTEN CONSENT OF THE COPYRIGHT HOLDER. CONTRACTOR TO CHECK AND VERIFY ALL LEVELS, DATUMS, A DIMENSIONS ON SITE AND SHALL REPORT ANY DISCREPANCIES OR OMISSIONS TO THIS OFFICE PRIOR TO START OF WORK & DURING THE CONSTRUCTION PHASE. THIS DRAWING IS TO BE READ AND UNDERSTOOD IN CONJUNCTION WITH STRUCTURAL, MECHANICAL, ELECTRICAL AND OR ANY OTHER CONSULTANTS DOCUMENTATION AS MAY BE APPLICABLE TO THE PROJECT PRIOR TO START OF WORK & ITS DURATION. MEASUREMENT SCALING OF THIS DRAWING SHALL ONLY BE PERMITTED IN ITS DIGITAL FORM.

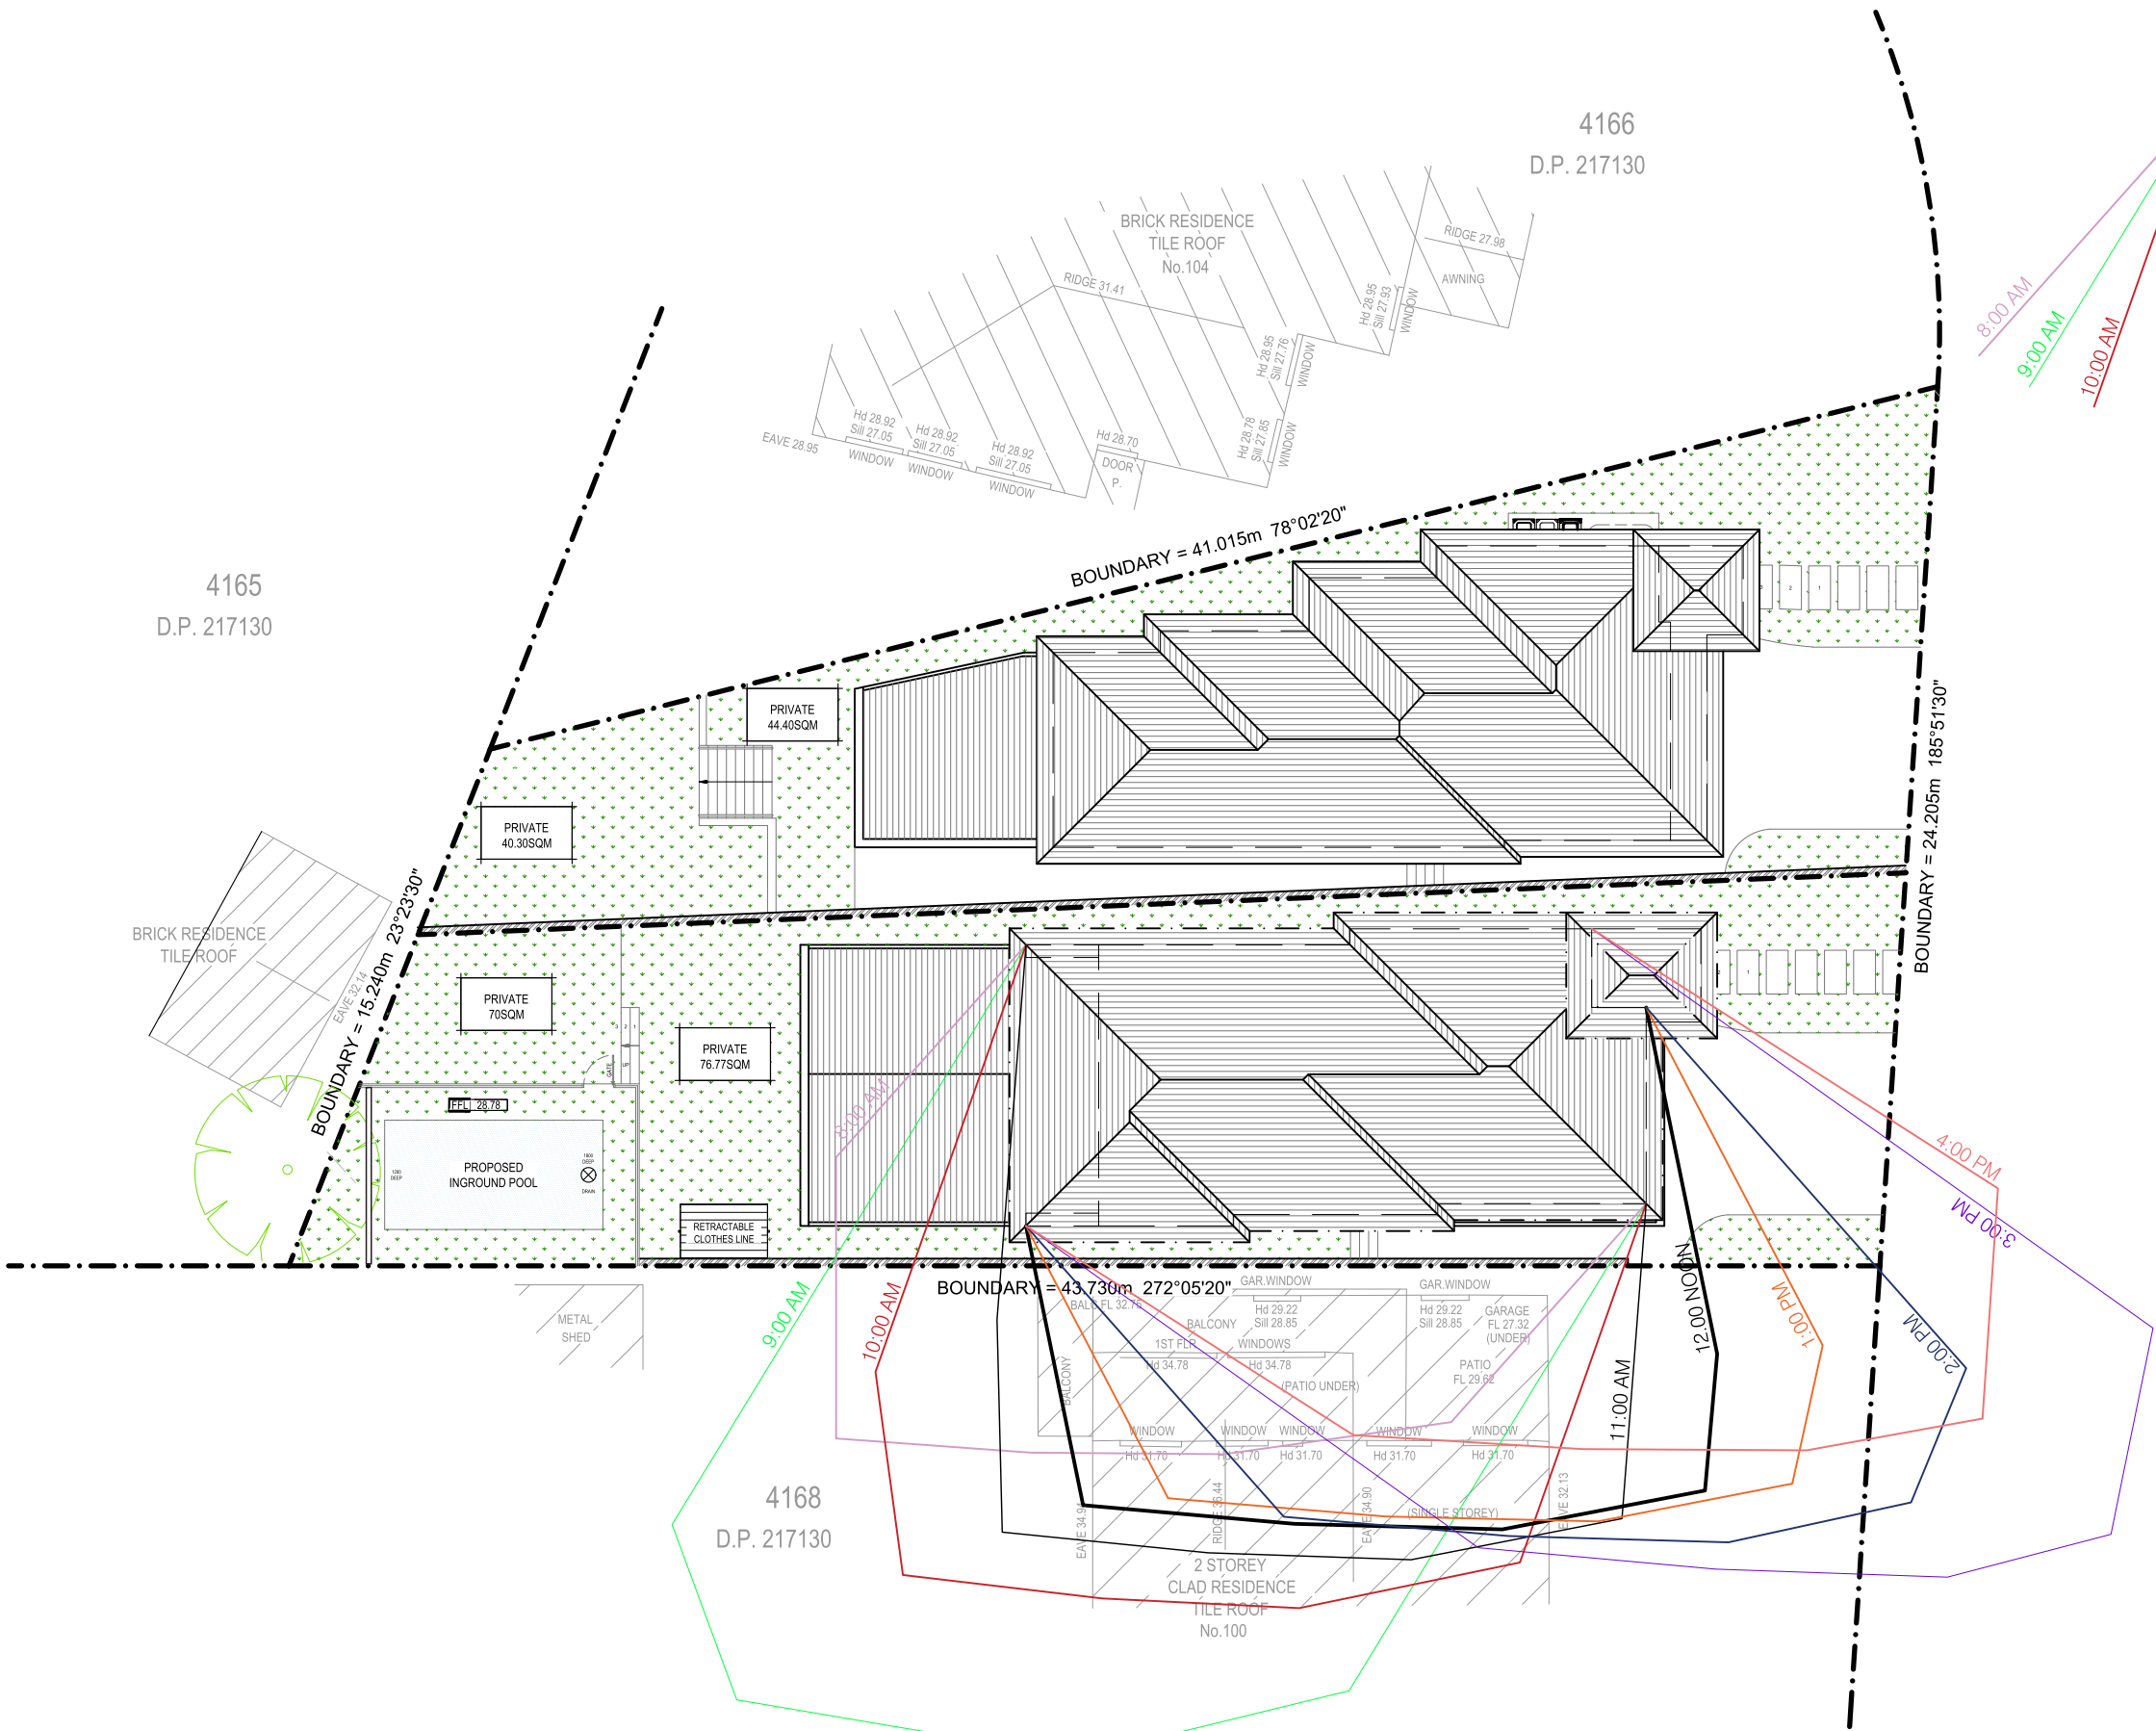

PROPOSED SHADOW DIAGRAMS JUNE 21ST 9AM, 12PM & 3PM
SCALE - 1 : 200



03	AS PER COUNCIL REQUIREMENTS	SK	04.11.2024
02	AS PER COUNCIL REQUIREMENTS	SK	04.07.2024
01	DEVELOPMENT APPLICATION	SK	11.04.2023
REV	AMENDMENT DETAILS	BY	DATE

PROJECT STAGE
DEVELOPMENT APP.

PROJECT DETAILS
DETACHED DUAL-OCC
102 SANDAKAN ROAD,
REVESBY HEIGHTS

CLIENT DETAILS
LIVINGSTON HOMES

DRAWING TITLE
**PROPOSED UNIT 1 SHADOW
DIAGRAMS - JUNE 21**

DRAWN
SK
DESIGNED
FB
CHECK
FB
DATE DRAWN
JULY 2024
DRAWING SCALE
1 : 200
SHEET SIZE
A3



0 1m 2m 3m 4m 5m 6m 7m 8m 9m 10m
X 1:100 @ A1 1:200 @ A3 1:267 @ A4

bdad
**ACCREDITED
BUILDING DESIGNER**

ACCREDITATION NUMBER: 6613 - MEMBER NUMBER 6763-21

PROJECT NUMBER FB0077	DRAWING NUMBER A.06.1	REVISION 03
--------------------------	--------------------------	----------------

COPYRIGHT 2023 FEMME BUILD
REPRODUCTION OF THE WHOLE OR PART OF THIS DOCUMENT CONSTITUTES AND INFRINGES COPYRIGHT. THE INFORMATION, IDEAS AND CONCEPTS CONTAINED IN THIS DOCUMENT IS / ARE CONFIDENTIAL. THE RECIPIENT(S) OF THIS DOCUMENT IS / ARE PROHIBITED FROM DISCLOSING SUCH INFORMATION IDEAS AND CONCEPTS TO ANY PERSON WITHOUT PRIOR WRITTEN CONSENT OF THE COPYRIGHT HOLDER. CONTRACTOR TO CHECK AND VERIFY ALL LEVELS, DATUMS, A DIMENSIONS ON SITE AND SHALL REPORT ANY DISCREPANCIES OR OMISSIONS TO THIS OFFICE PRIOR TO START OF WORK & DURING THE CONSTRUCTION PHASE. THIS DRAWING IS TO BE READ AND UNDERSTOOD IN CONJUNCTION WITH STRUCTURAL, MECHANICAL, ELECTRICAL AND OR ANY OTHER CONSULTANTS DOCUMENTATION AS MAY BE APPLICABLE TO THE PROJECT PRIOR TO START OF WORK & ITS DURATION. MEASUREMENT SCALING OF THIS DRAWING SHALL ONLY BE PERMITTED IN ITS DIGITAL FORM.

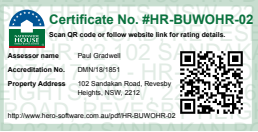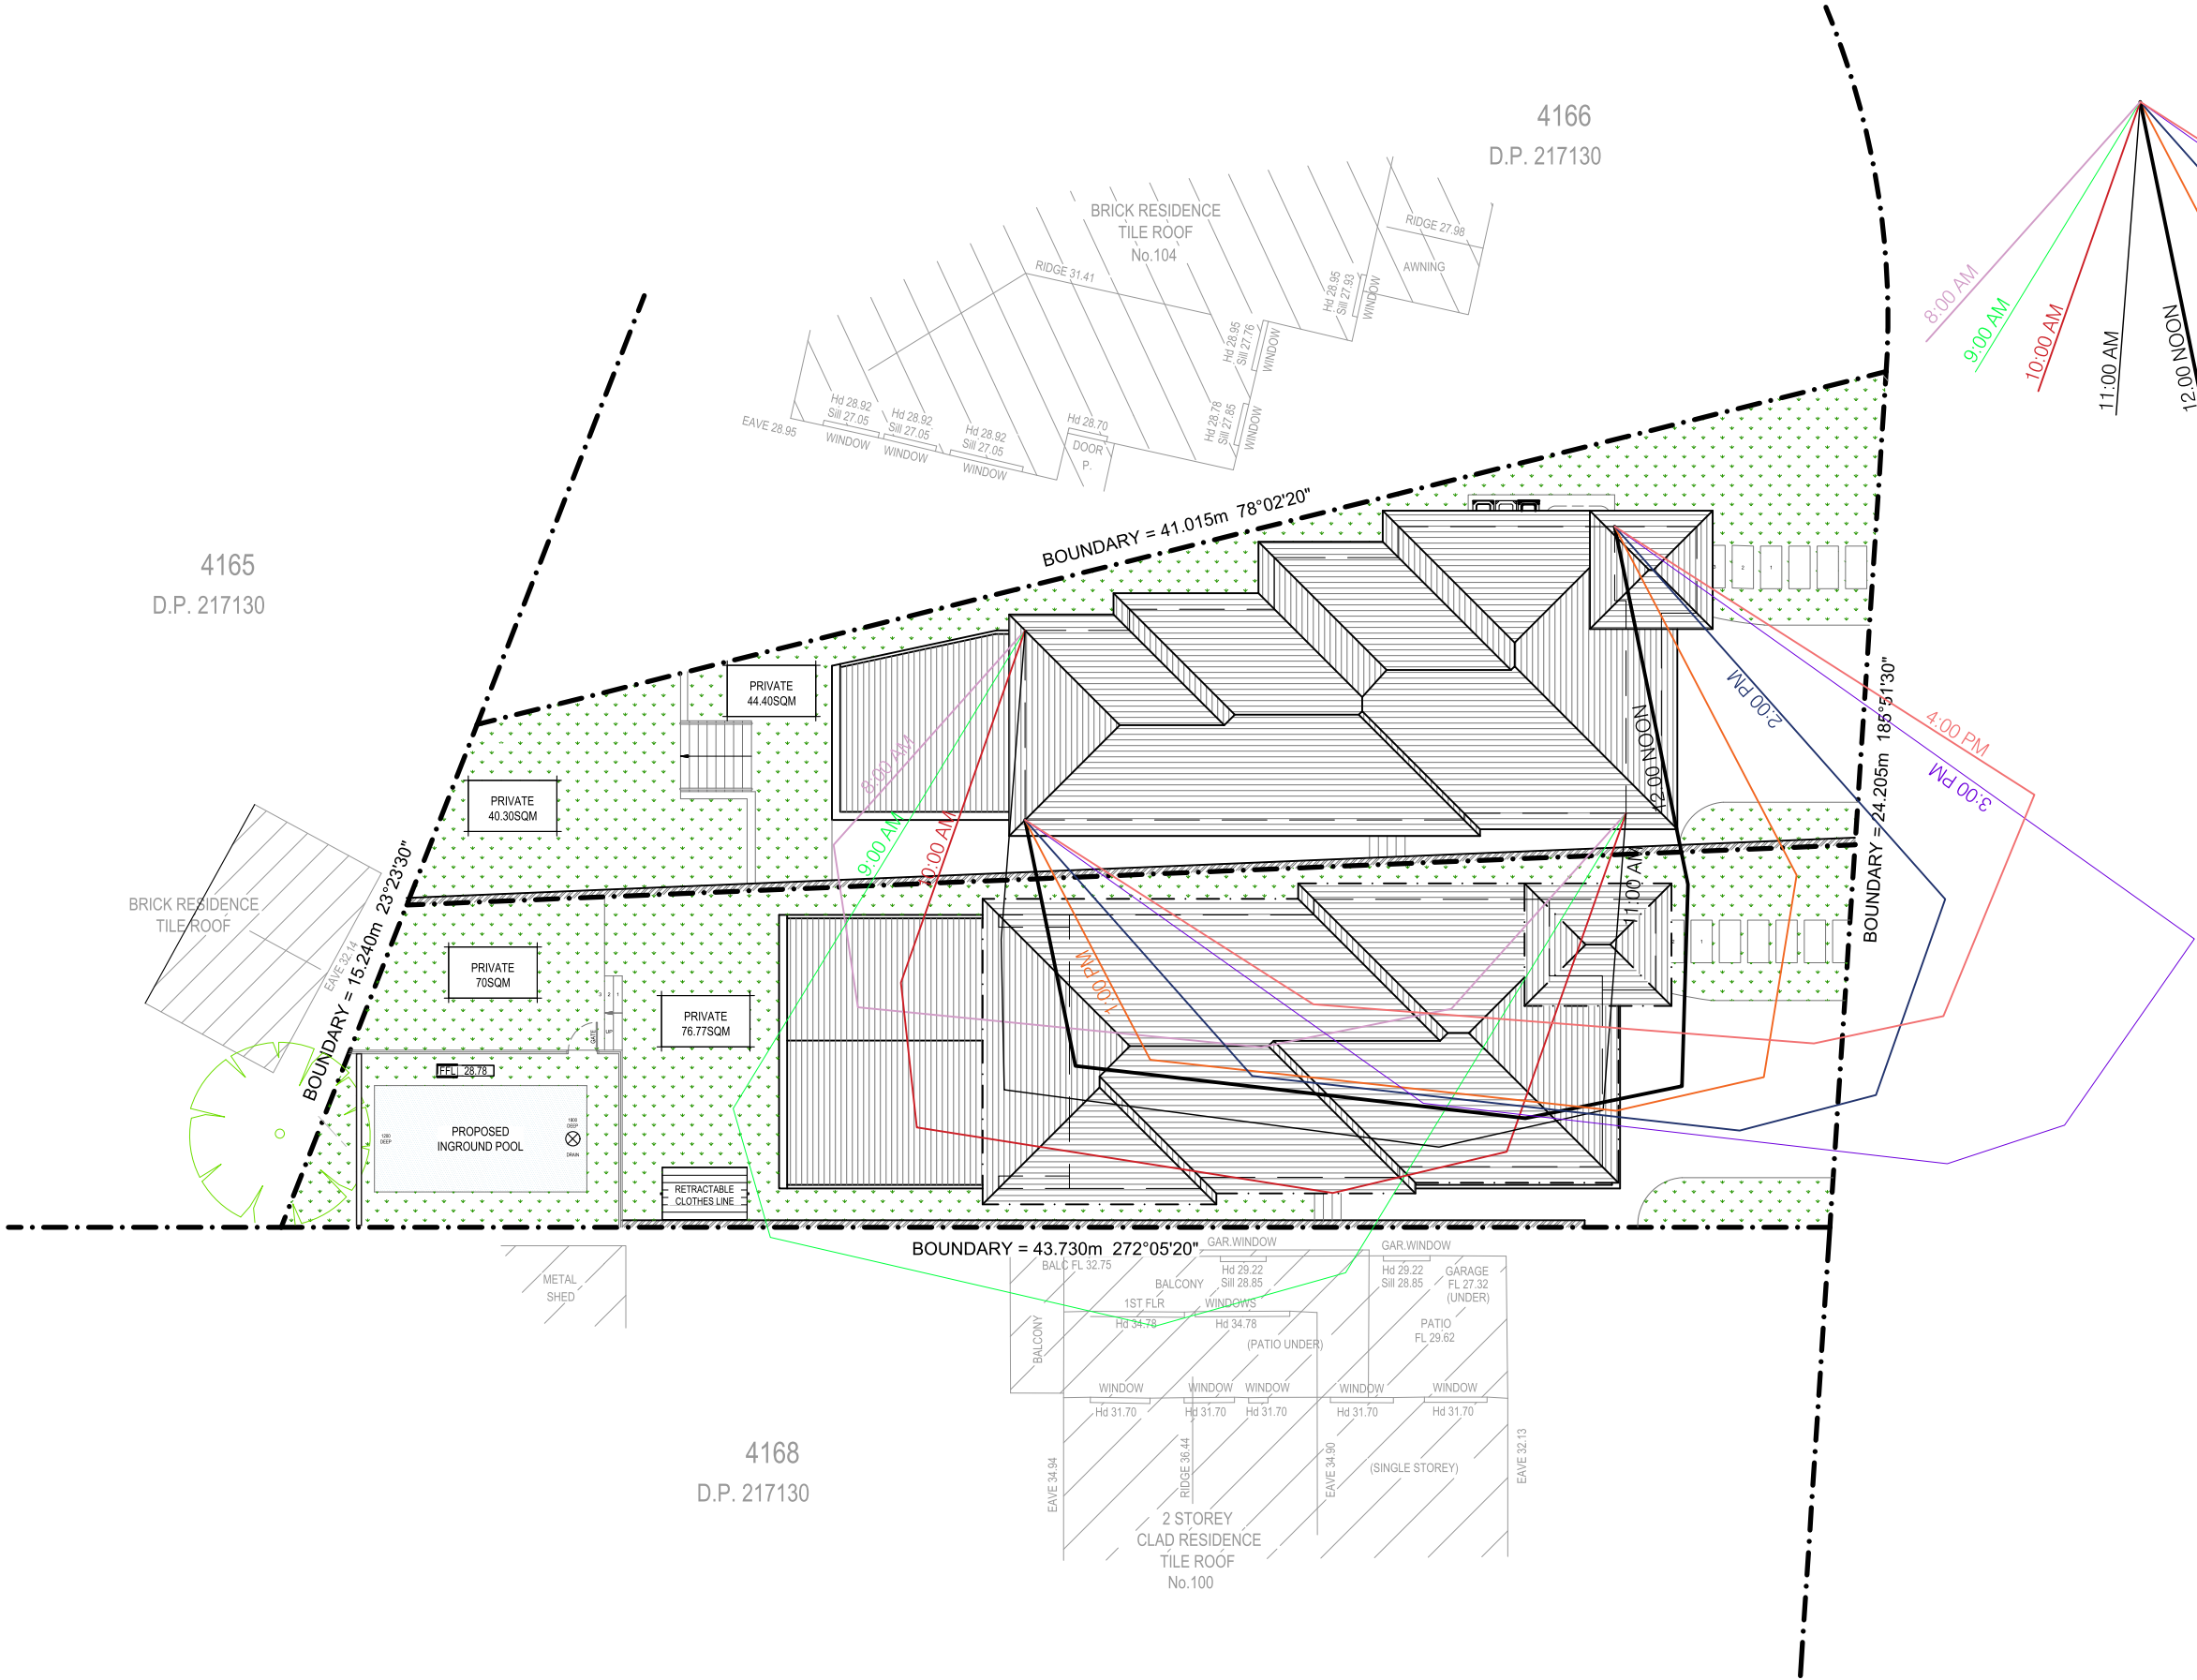

03	AS PER COUNCIL REQUIREMENTS	SK	04.11.2024
02	AS PER COUNCIL REQUIREMENTS	SK	04.07.2024
01	DEVELOPMENT APPLICATION	SK	11.04.2023
REV	AMENDMENT DETAILS	BY	DATE

PROJECT STAGE
DEVELOPMENT APP.

PROJECT DETAILS
DETACHED DUAL-OCC
**102 SANDAKAN ROAD,
REVESBY HEIGHTS**

CLIENT DETAILS
LIVINGSTON HOMES

DRAWING TITLE
**PROPOSED UNIT 2 SHADOW
DIAGRAMS - JUNE 21**

DRAWN
SK
DESIGNED
FB
CHECK
FB

DATE DRAWN
JULY 2024
DRAWING SCALE
1:200
SHEET SIZE
A3

bdad
**ACCREDITED
BUILDING DESIGNER**

ACCREDITATION NUMBER: 6613 - MEMBER NUMBER 6763-21

PROJECT NUMBER
FB0077
DRAWING NUMBER
A.06.2
REVISION
03

PROPOSED SHADOW DIAGRAMS JUNE 21ST 9AM, 12PM & 3PM
SCALE - 1 : 200

The commitments set out below regulate how the proposed development is to be carried out. It is a condition of any development consent granted, or complying development certificate issued, for the proposed development, that BASIX commitments be complied with.

(a) Dwellings

BABIX Department of Planning and Environment www.babix.nsw.gov.au Version: 4.02 / EUCALYPTUS_03_01_0 Certificate No.: 1745417M Monday, 29 April 2024 page 1

	Thermal loads		
Dwellings	Maximum heating load in MW (t)	Maximum cooling load in MW (t)	Maximum total load in MW (t)
1	19.3	10.5	29.800
All other dwellings	20.1	9.9	30.000

BABIX Department of Planning and Environment www.babix.nsw.gov.au Version: 4.02 / EUCALYPTUS_03_01_0 Certificate No.: 1745417M Monday, 28 April 2024 page 1

BASIX Department of Planning and Environment www.basix.nsw.gov.au Version: 4.02 / EUCALYPTUS_03_01_0 Certificate No.: 1746417M Monday, 20 April 2024 page

ASIX Department of Planning and Environment www.basix.nsw.gov.au Version: 4.02 / EUCALYPTUS 03_01_0 Certificate No: 1746417M Monday, 20 April 2024 page 10

(a) **Dwellings**

ASIX Department of Planning and Environment www.basix.nsw.gov.au Version: 4.02 / EUCALYPTUS_03_01_0 Certificate No.: 1746417M Monday, 20 April 2024 page 14

(b) Common areas and central systems/facilities

SIIX Department of Planning and Environment www.basix.nsw.gov.au Version: 4.02 / EUCALYPTUS_03_01_0 Certificate No.: 1746417M Monday, 29 April 2024 page 17/10

[A80X](#)
[Department of Planning and Environment](#)
[www.besic.nsw.gov.au](#)
Version: 4.02 / EUCALYPTUS_03_01_0
Certificate No.: 1745417M
Monday, 20 April 2024
page

181X Department of Planning and Environment www.basix.nsw.gov.au Version: 4.02 / EUCALYPTUS 03 01 0 Certificate No.: 1745417M Monday, 20 April 2024 page 1

COPYRIGHT 2023 FEMME BUILD

REPRODUCTION OF THE WHOLE OR PART OF THE DOCUMENT CONSTITUTES AND INFRINGES COPYRIGHT. THE INFORMATION, IDEAS AND CONCEPTS CONTAINED IN THIS DOCUMENT IS/ARE CONFIDENTIAL. THE RECIPIENT(S) OF THIS DOCUMENT IS/ARE PROHIBITED FROM DISCLOSING SUCH INFORMATION IDEAS AND CONCEPTS TO ANY PERSON WITHOUT PRIOR WRITTEN CONSENT OF THE COPYRIGHT HOLDER. CONTRACTOR TO CHECK AND VERIFY ALL LEVELS, DATUMS & DIMENSIONS ON SITE AND SHALL REPORT ANY DISCREPANCIES OR OMISSION TO THIS OFFICE PRIOR TO START OF WORK & DURING THE CONSTRUCTION PHASE. THIS DRAWING IS TO BE READ AND UNDERSTOOD IN CONNECTION WITH STRUCTURAL, MECHANICAL, ELECTRICAL AND OR ANY OTHER CONSULTANT'S DOCUMENTATION AS MAY BE APPLICABLE TO THE PROJECT PRIOR TO START OF WORK & ITS DURATION. MEASUREMENT SCALING OF THIS DRAWING SHALL ONLY BE PERMITTED IN ITS DIGITAL FORM.

Certificate No. #HR-BUWOHR
Scan QR code or follow website link for rating details.

Assessor name	Paul Gratwell
Accreditation No.	DMN181951
Property Address	102 Sandakan Road, Revesby Horseshoe Bay NSW 2206



DEVELOPMENT APP.

DRAWING TITLE

DAT
JU



ACCREDITATION NUMBER: 6613 - MEMBER NUMBER 6763-21

PROJECT NUMBER	DRAWING NUMBER	REVISION
FB0077	A.07.1	0